

ALL SITE PLAN MAK BANKING TIBURON INGTON, N

7 H


Licence #C-3641


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11/3/17 DATE





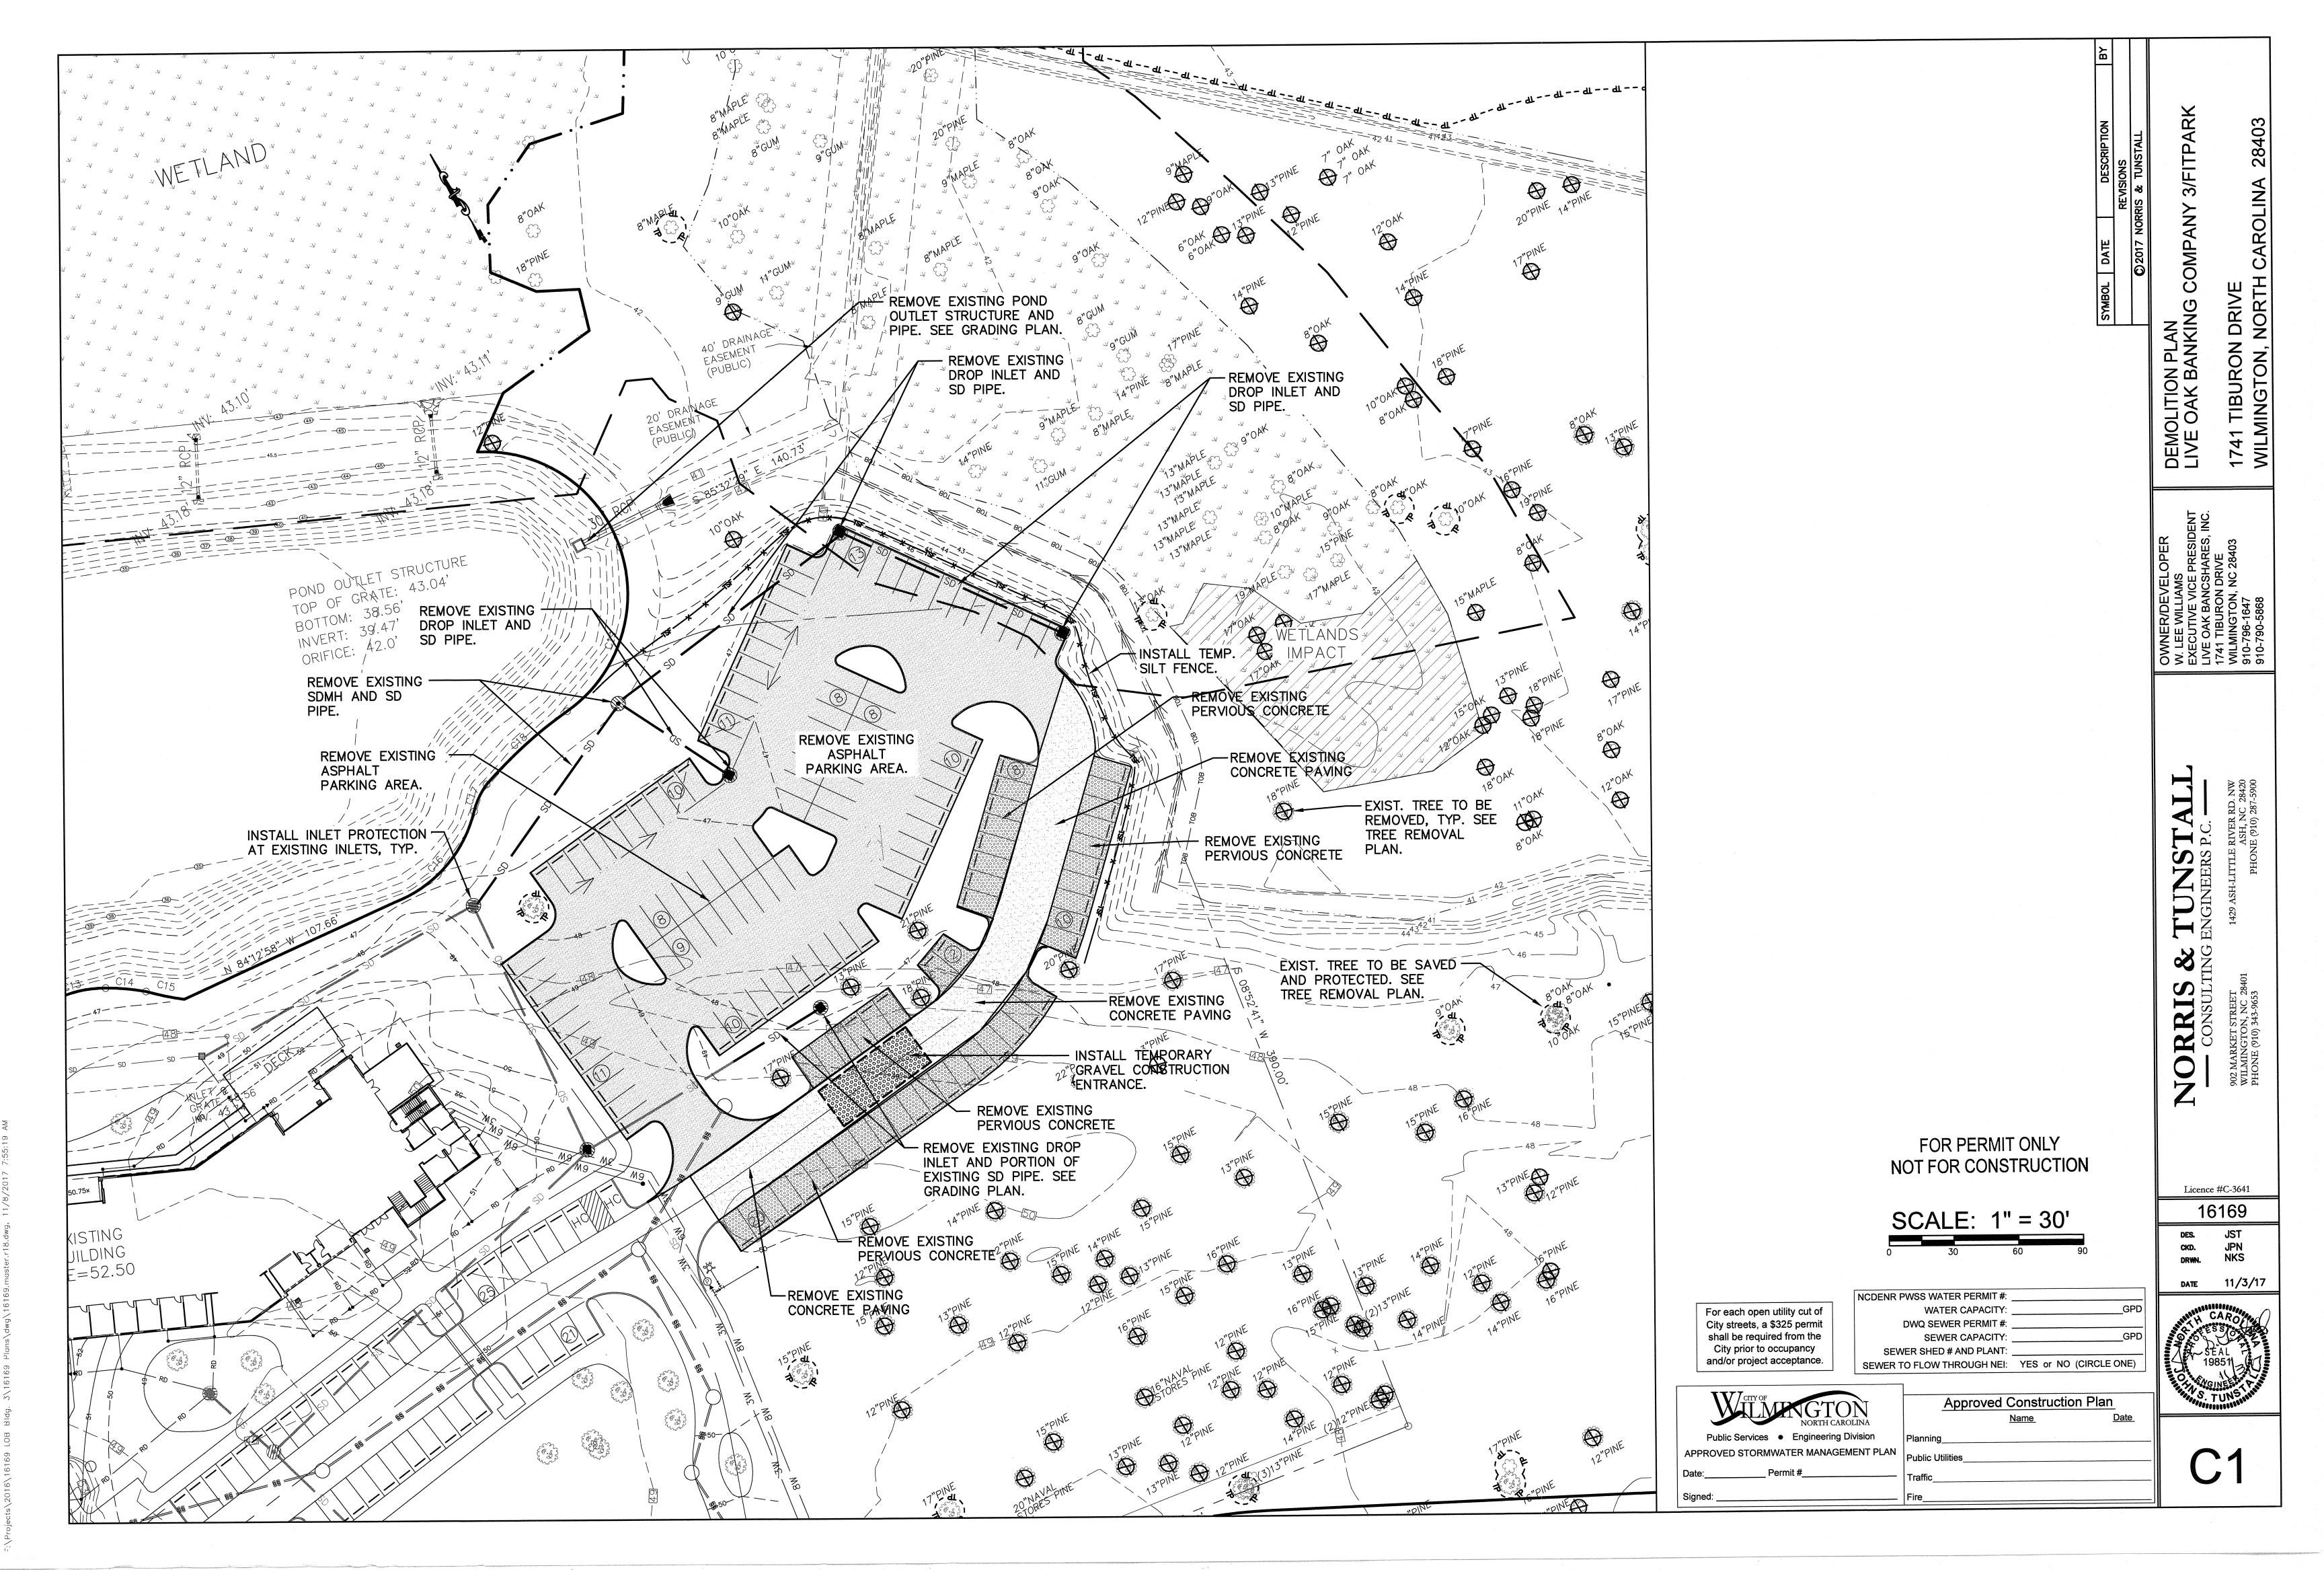


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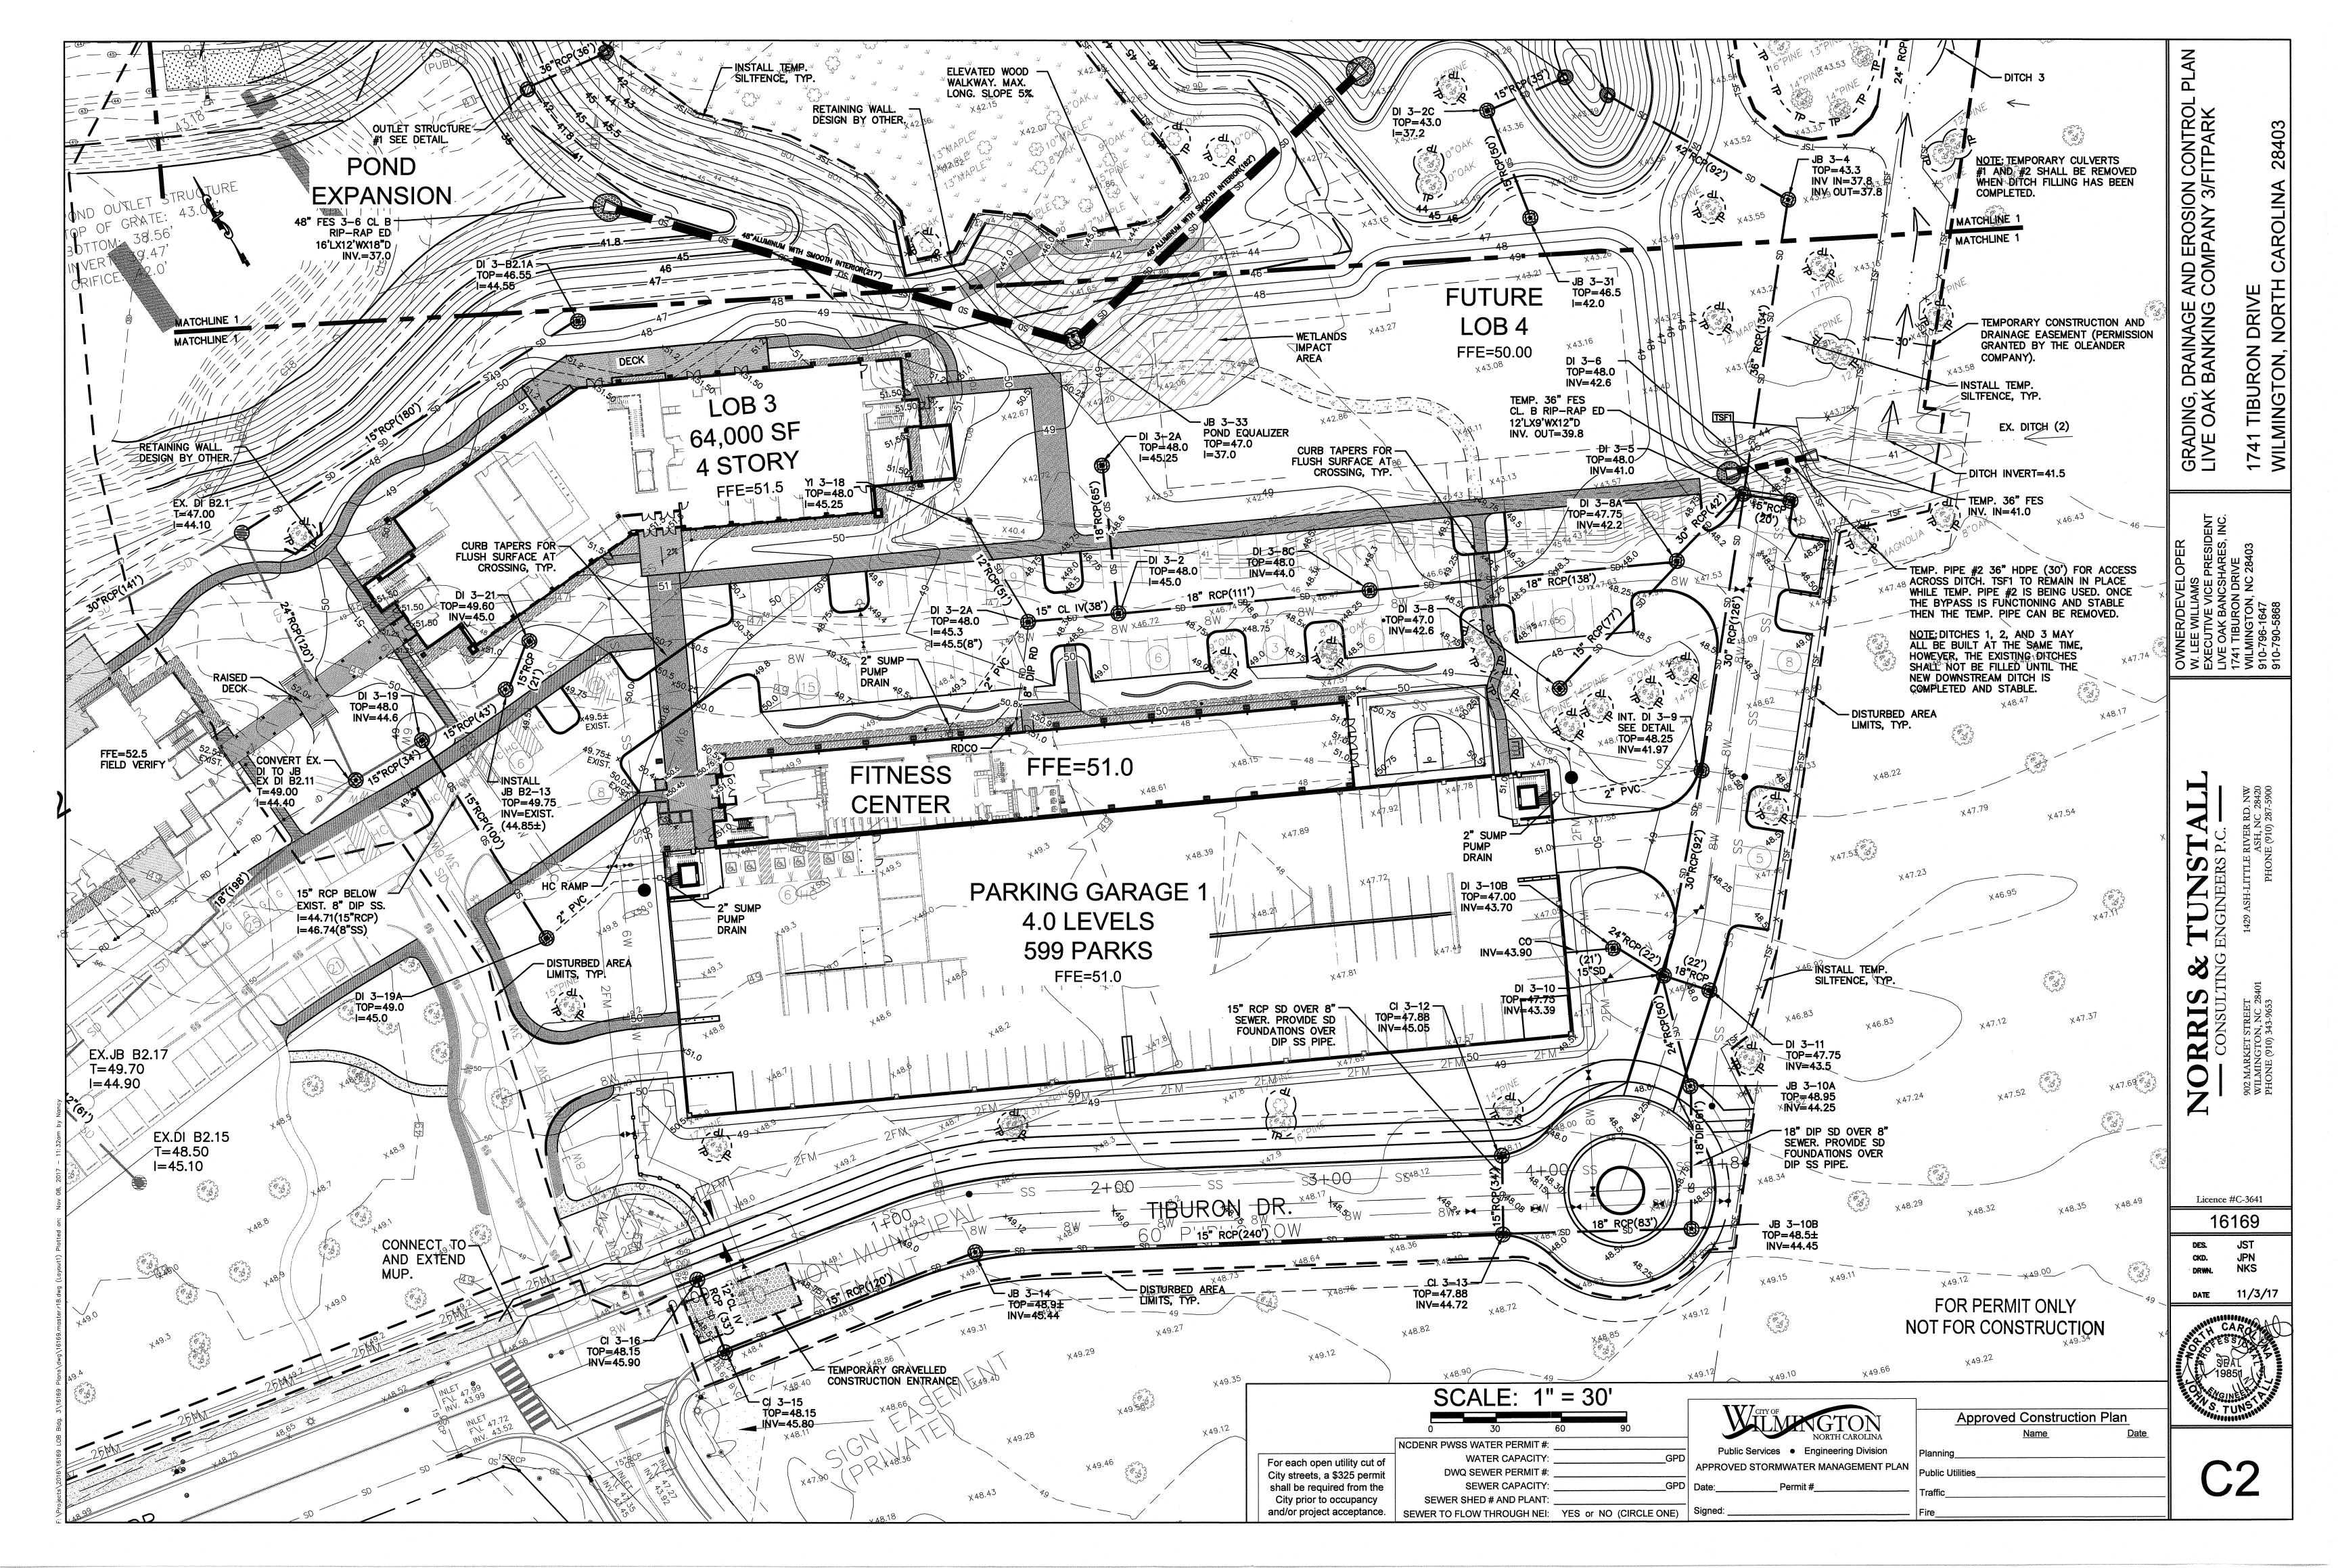
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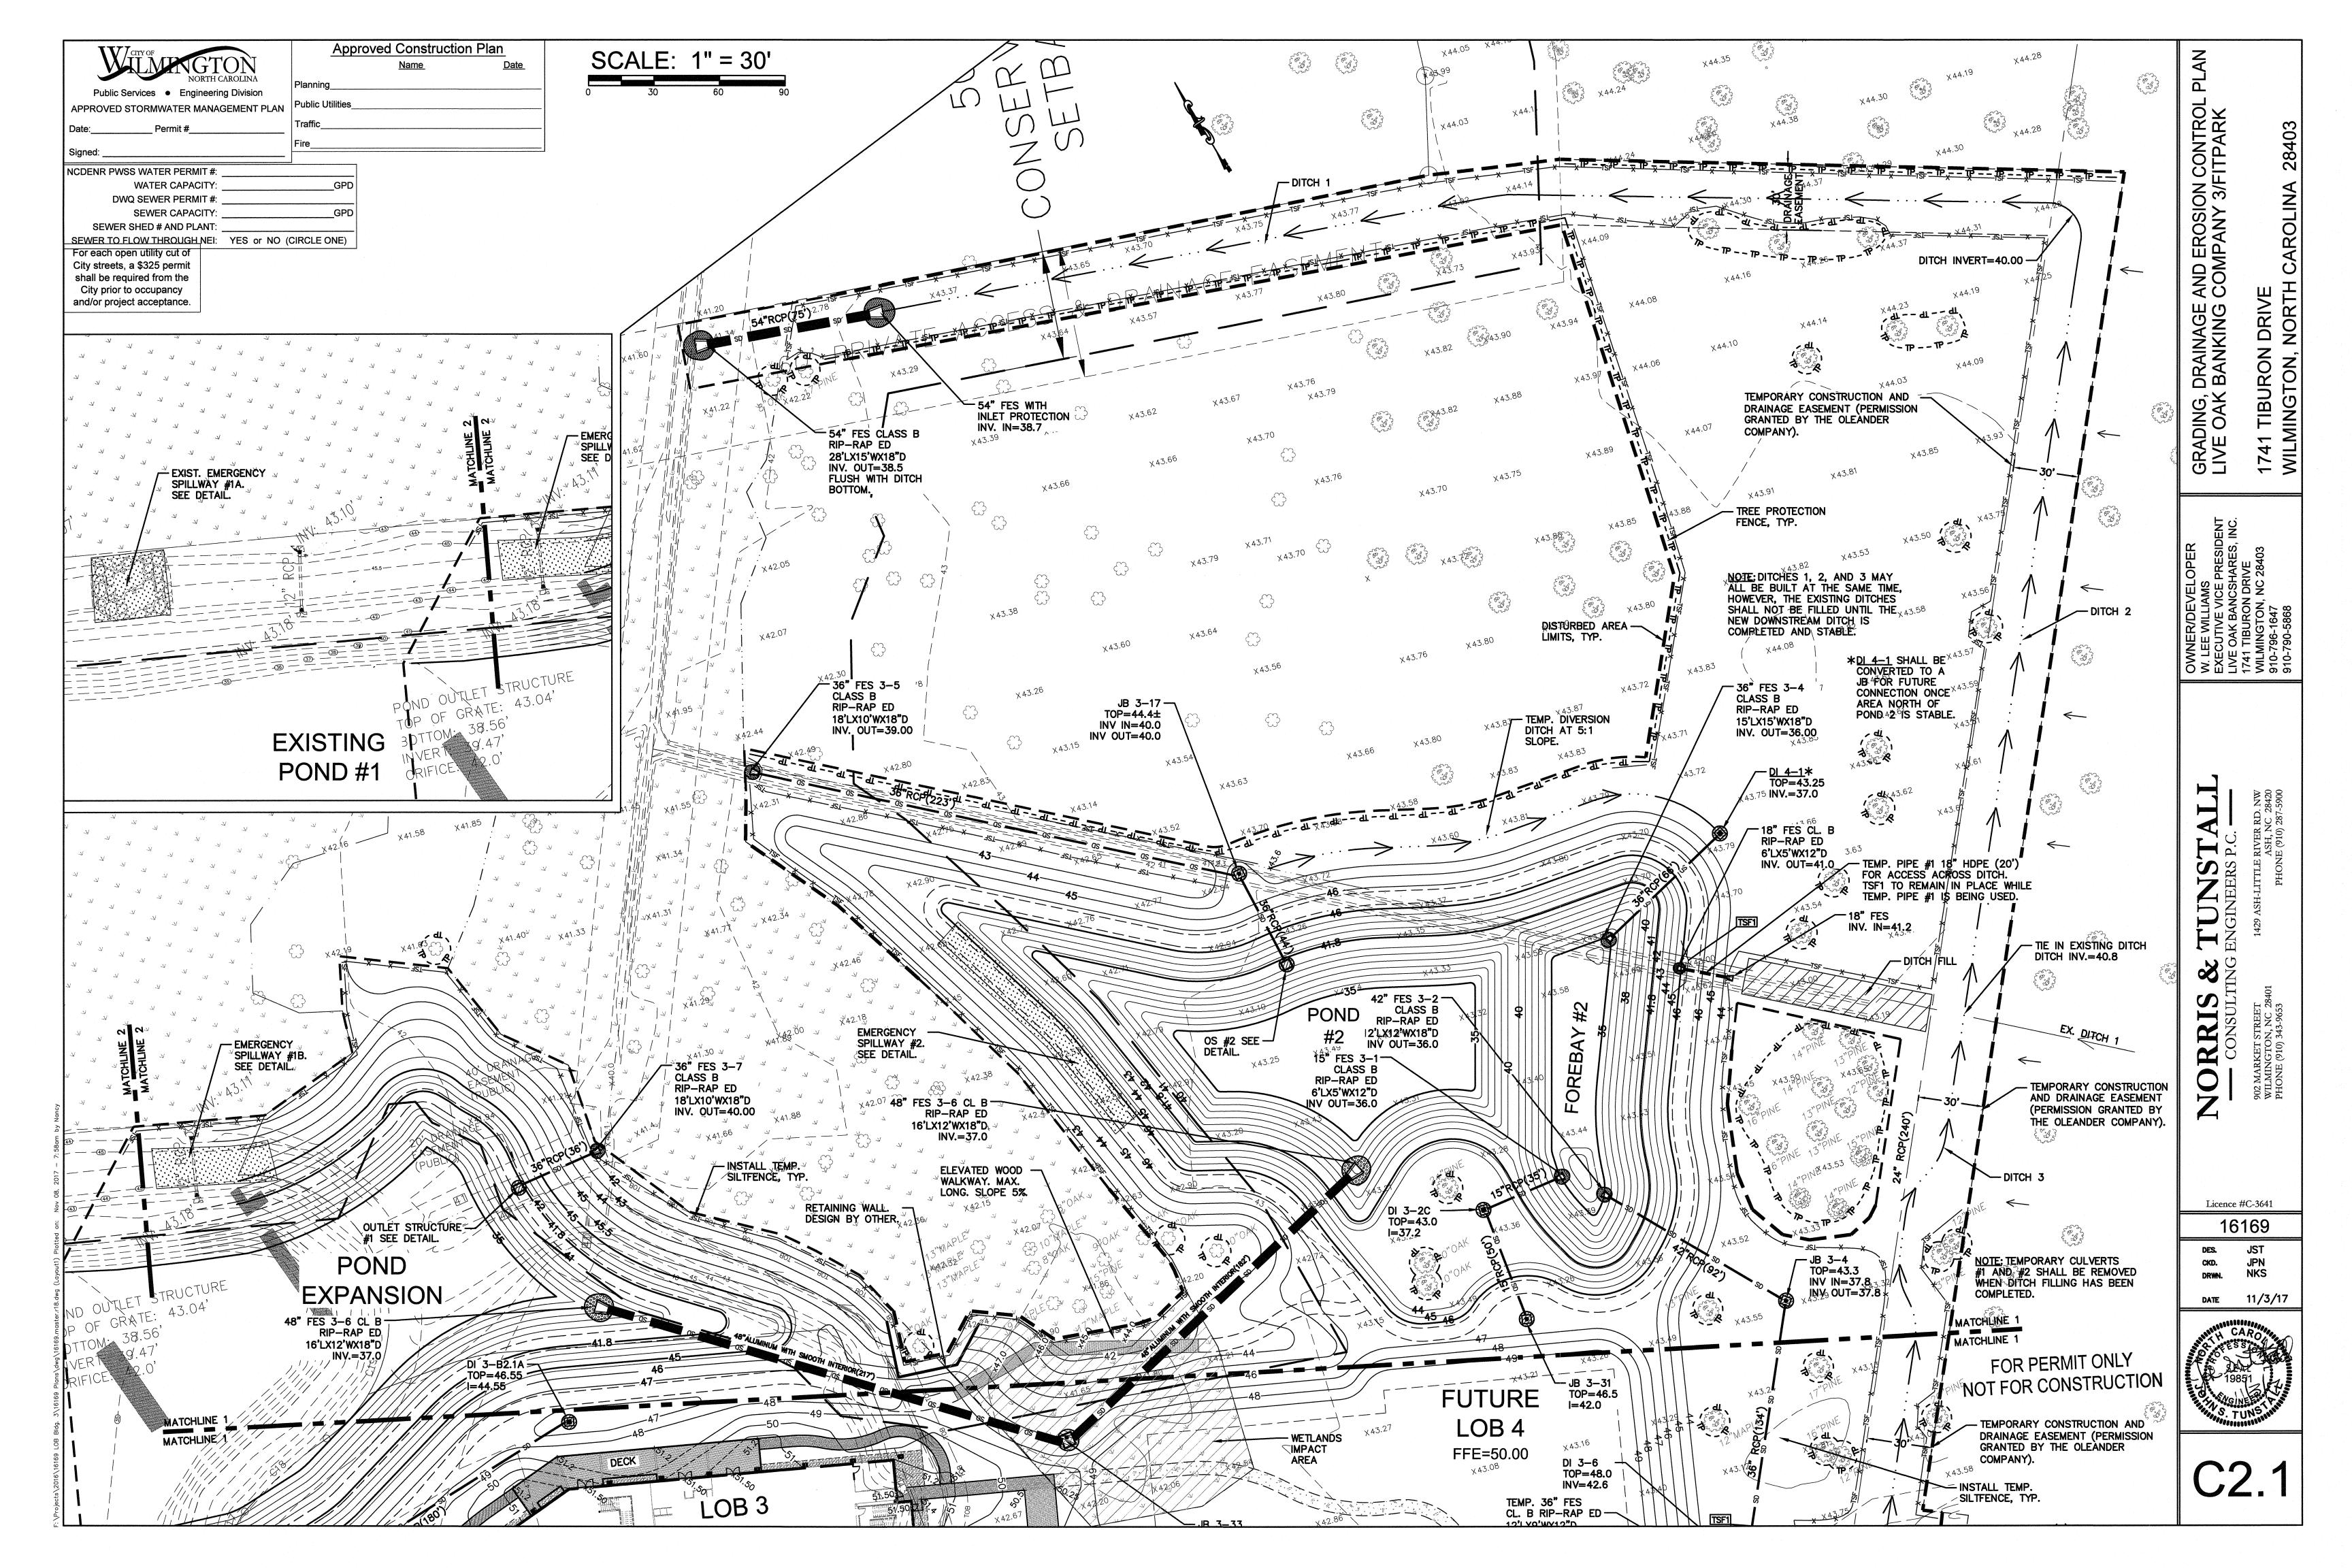
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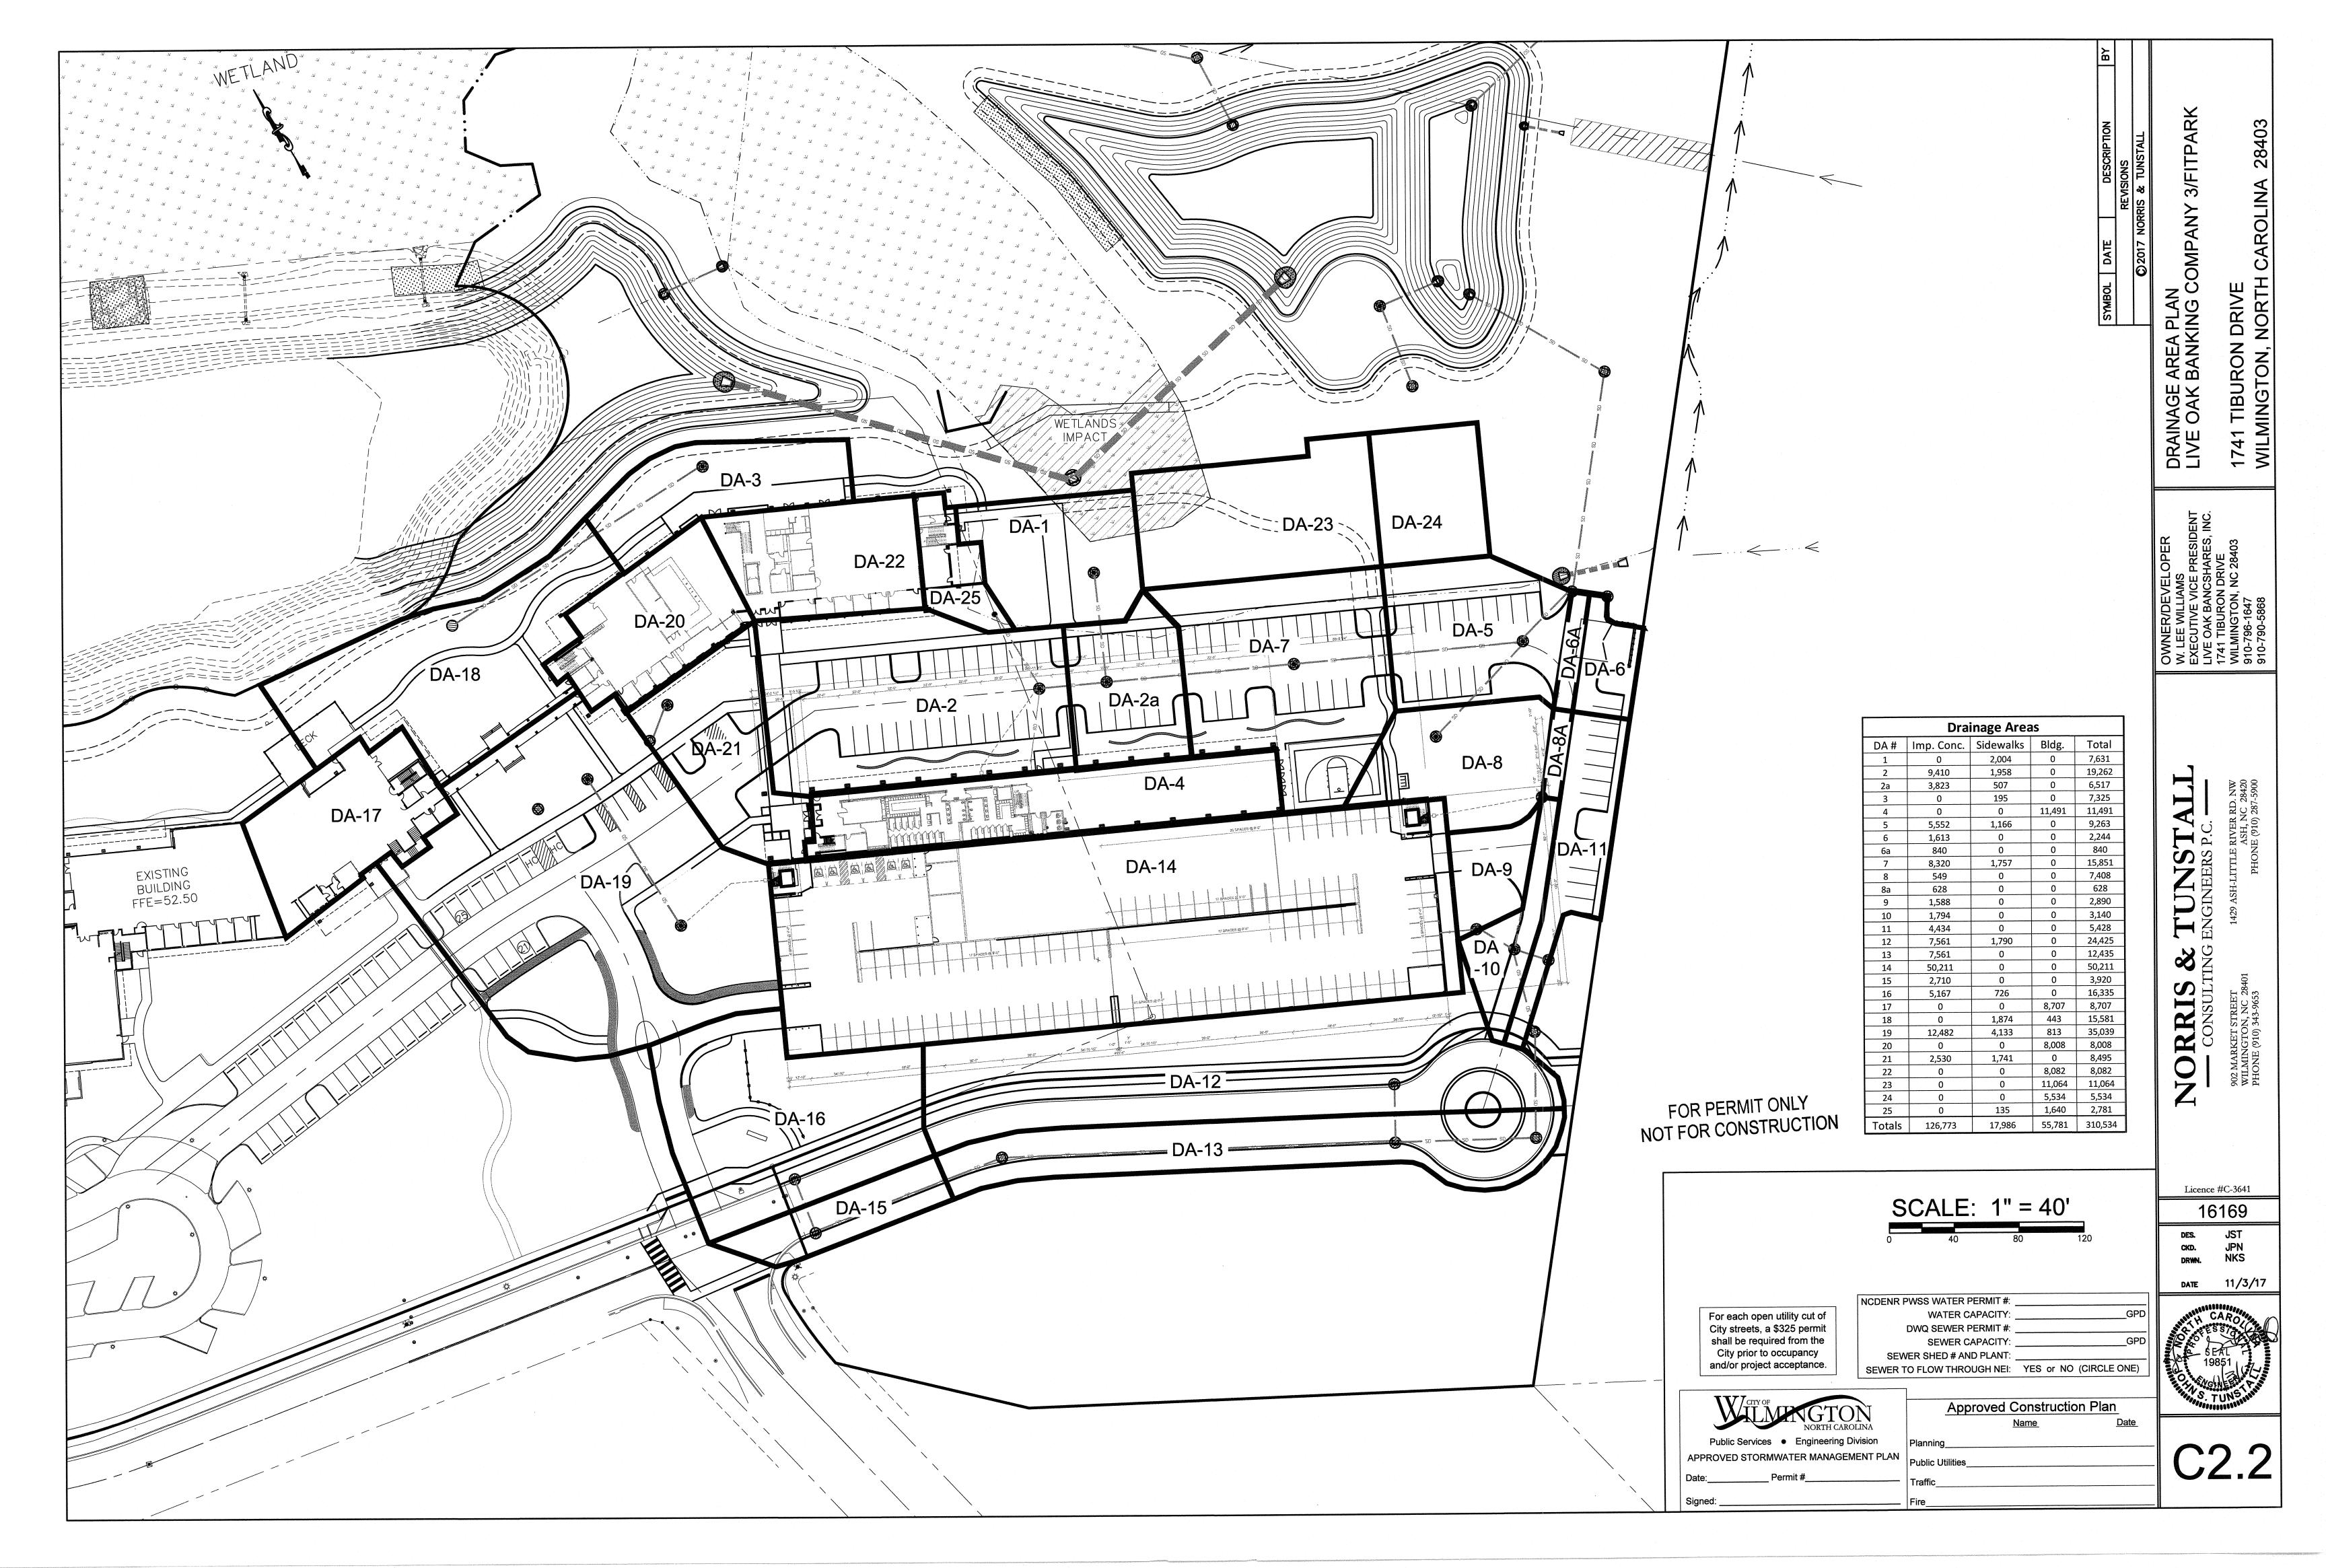
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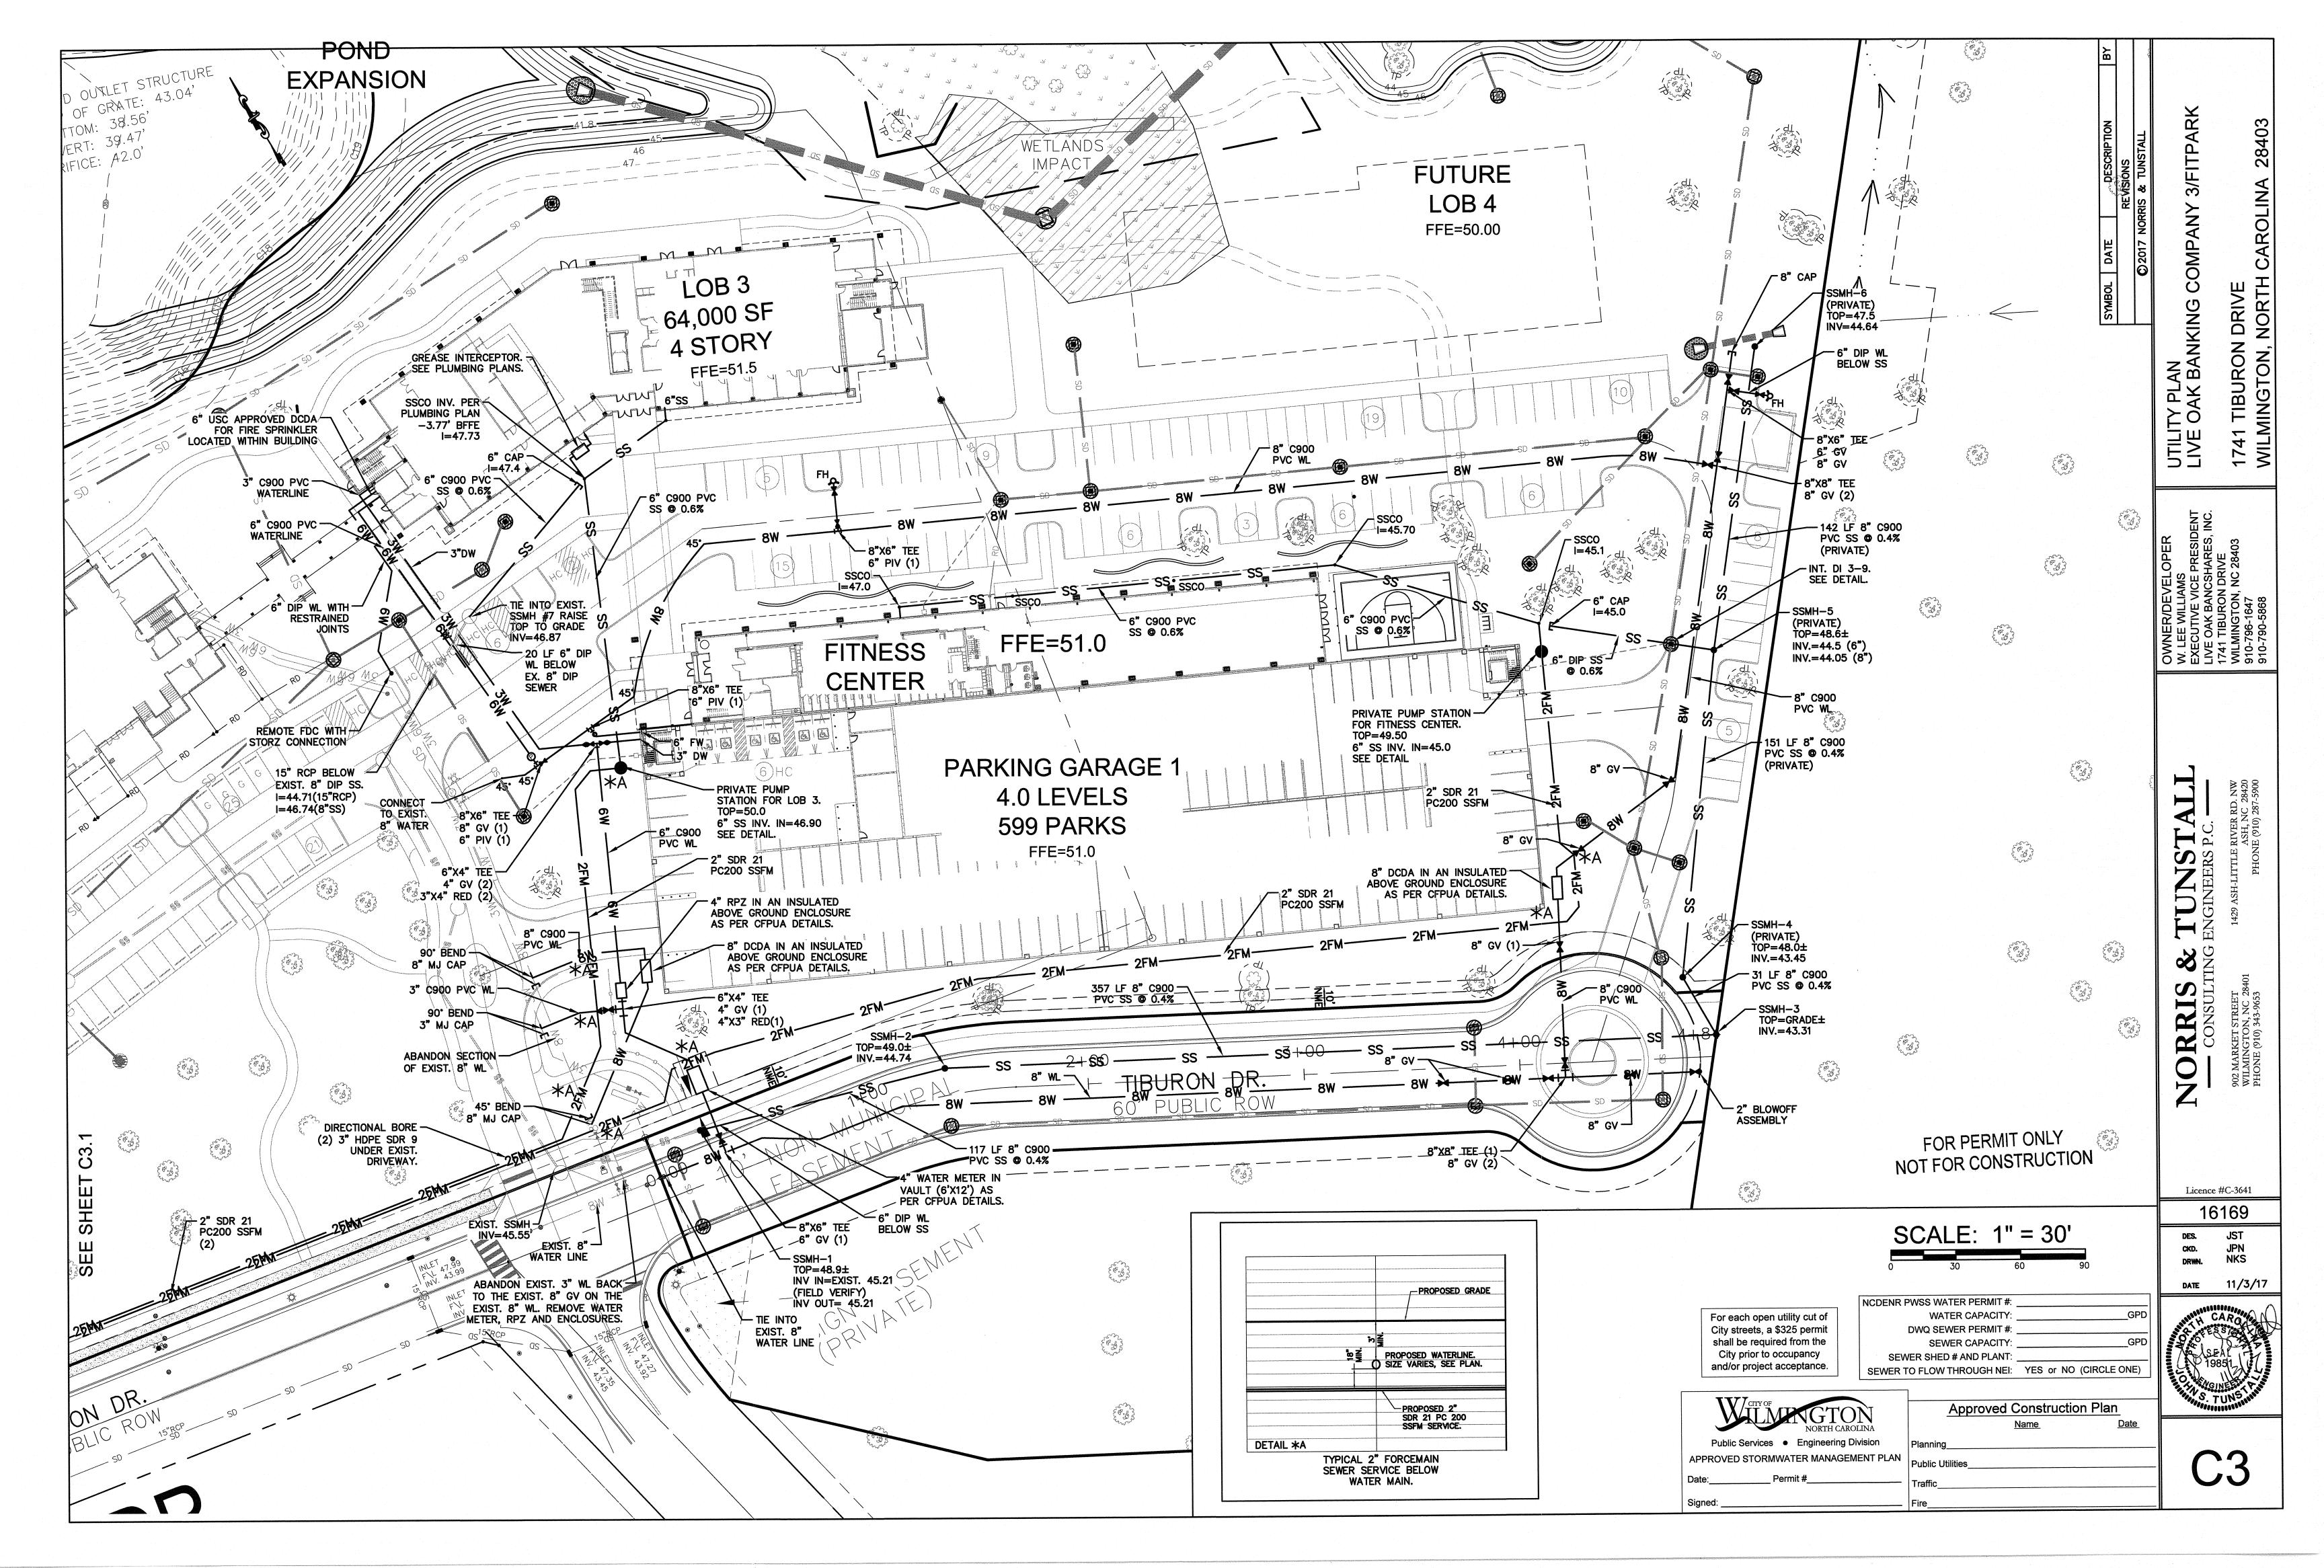
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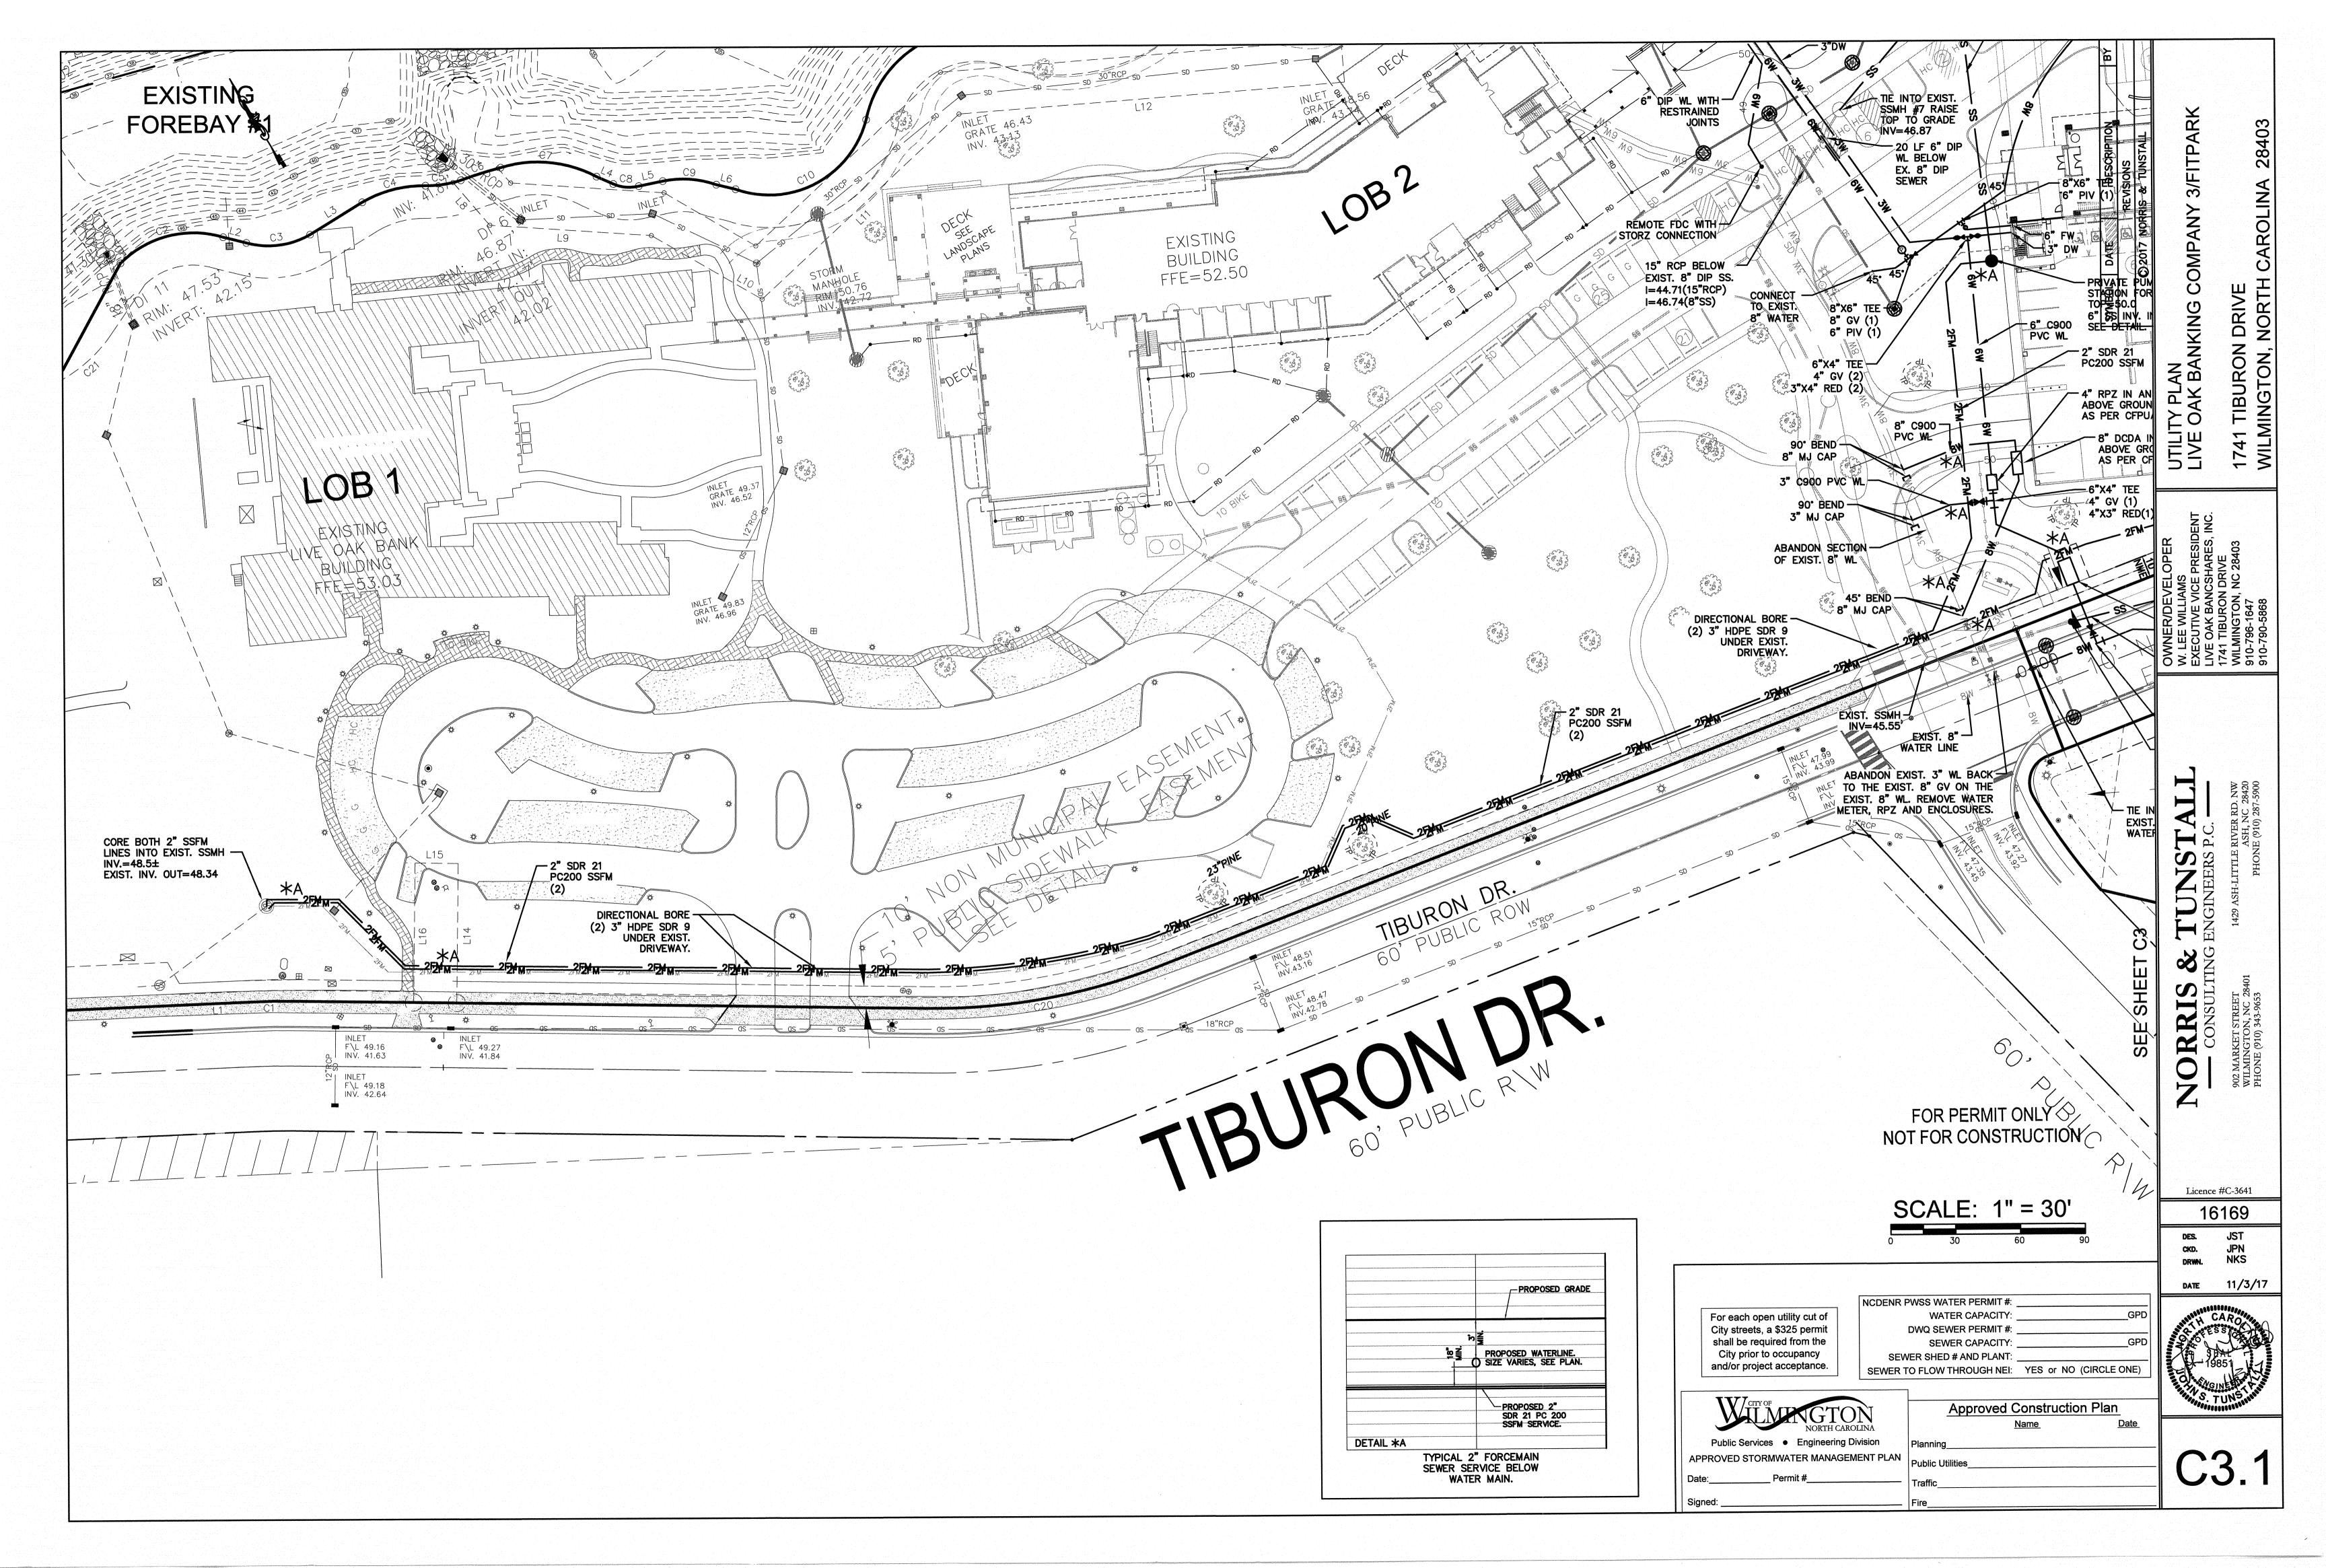


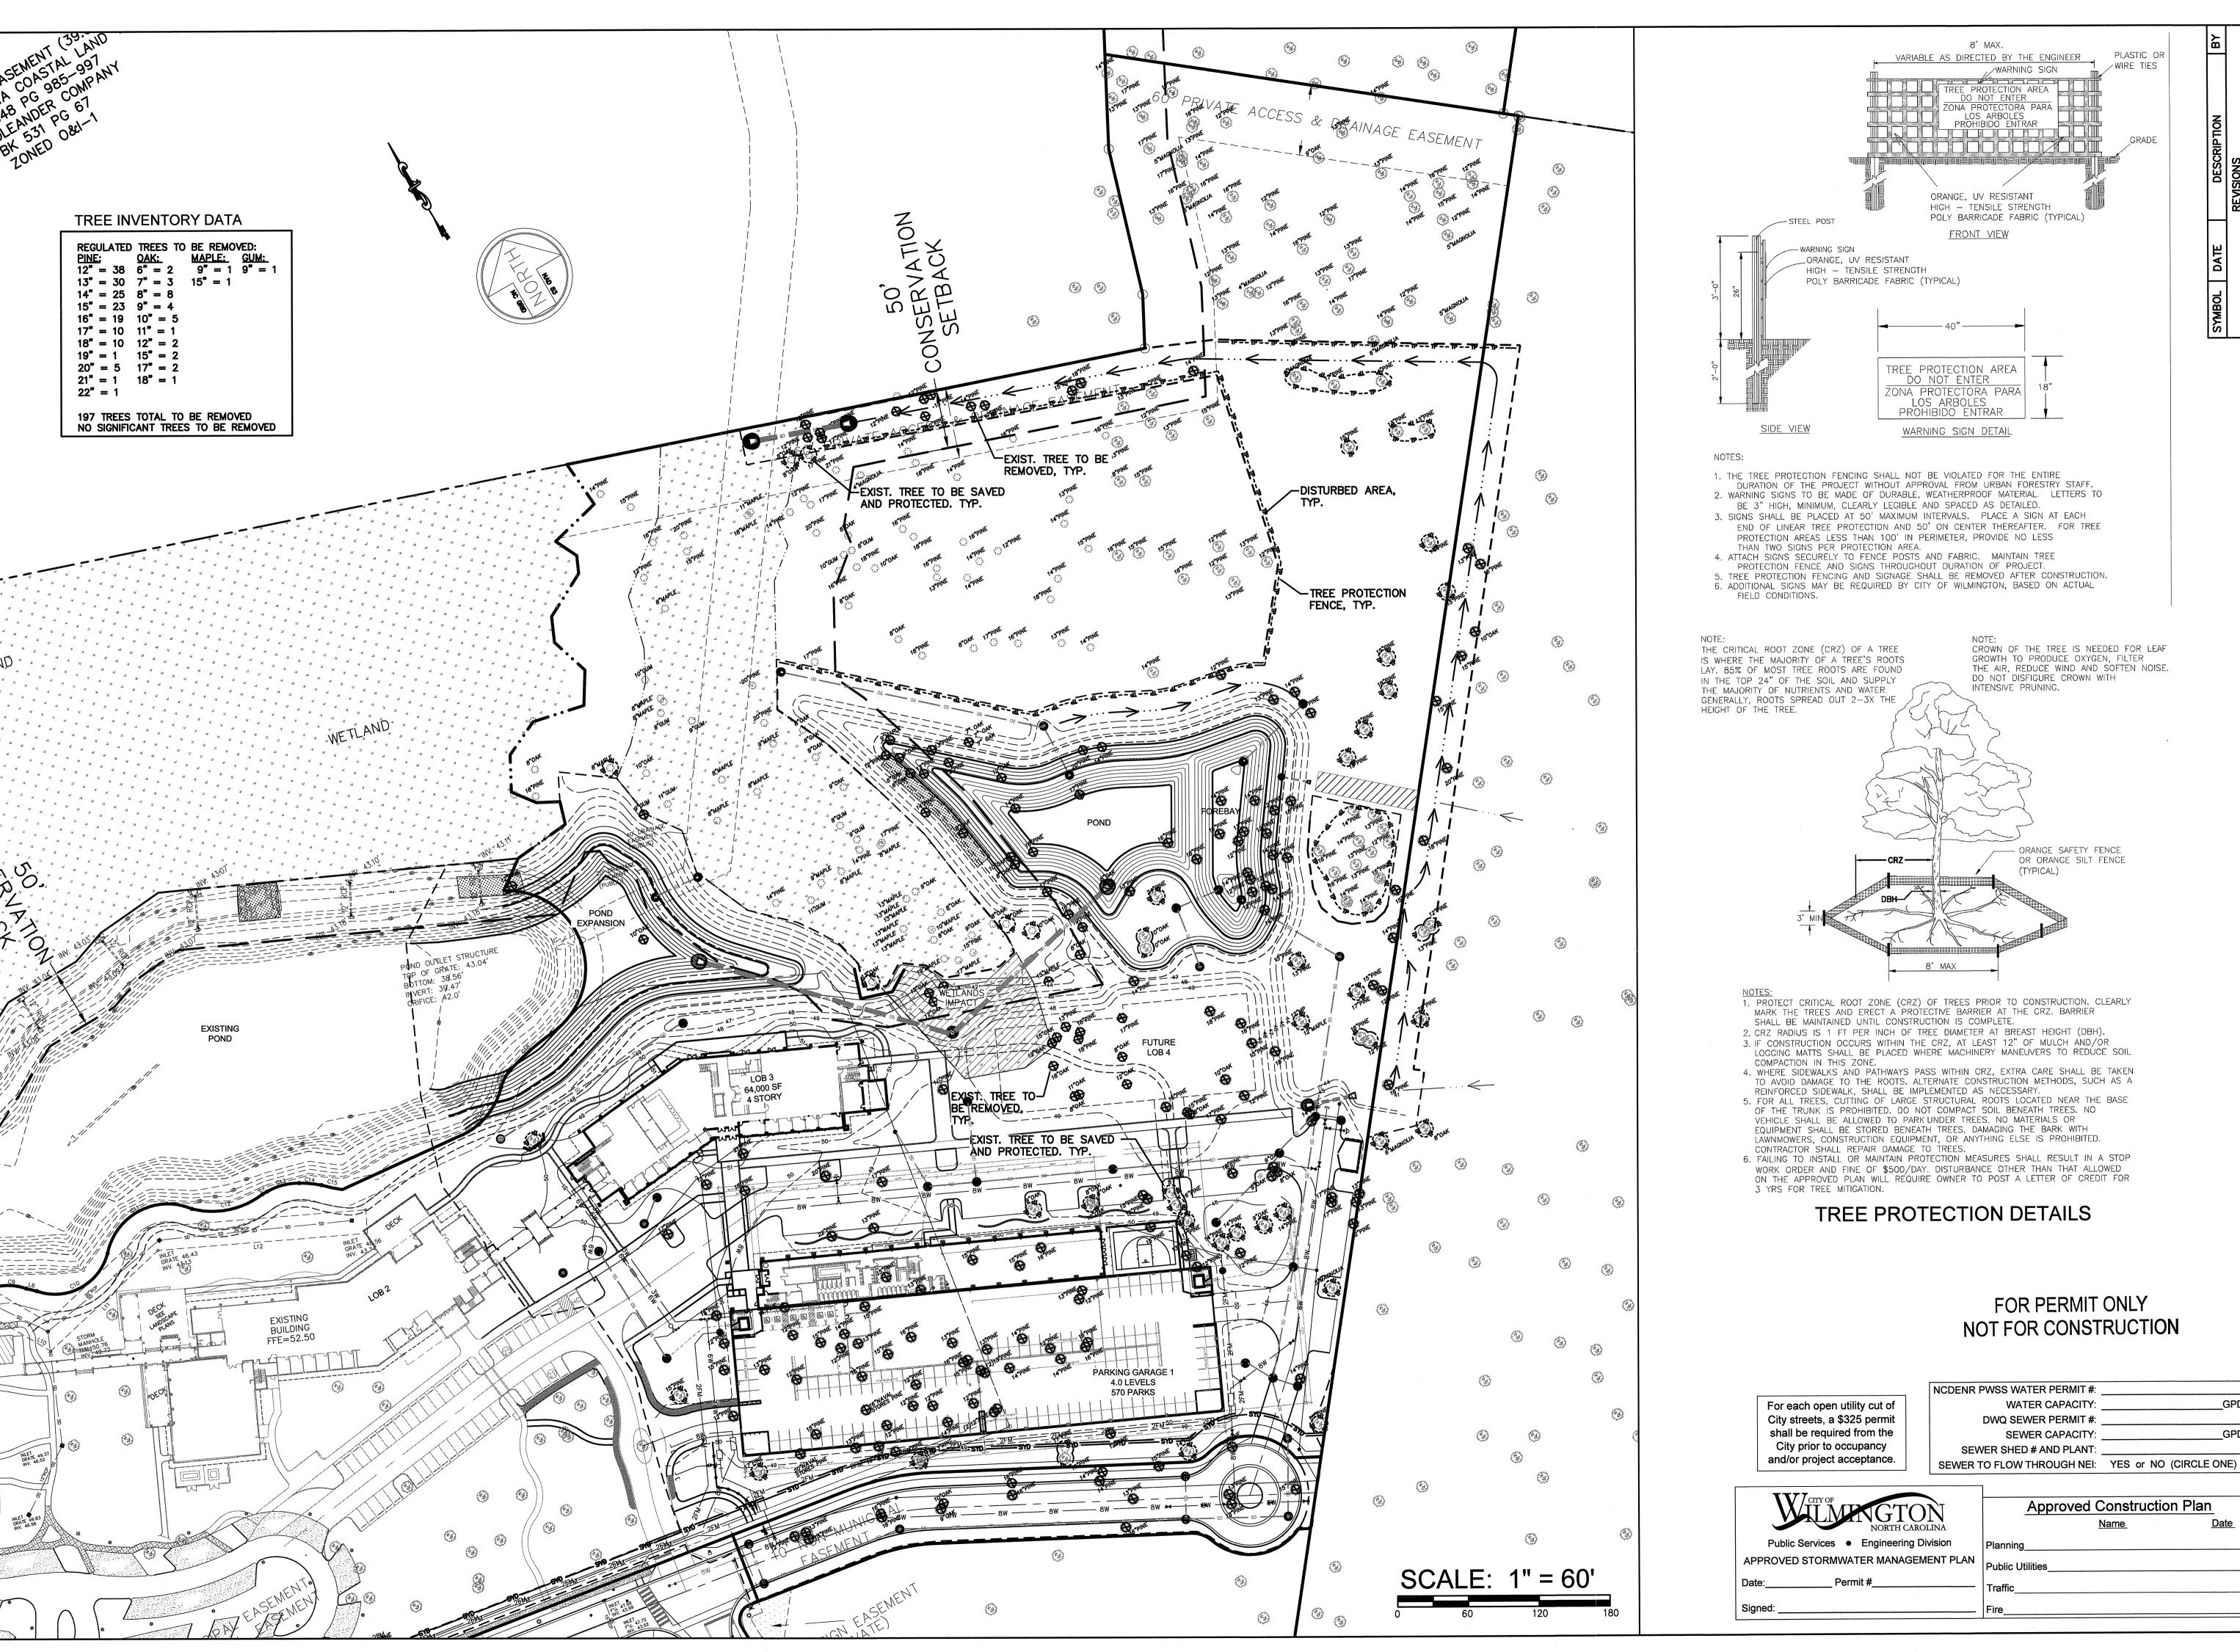









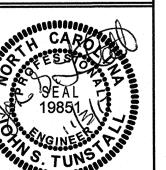

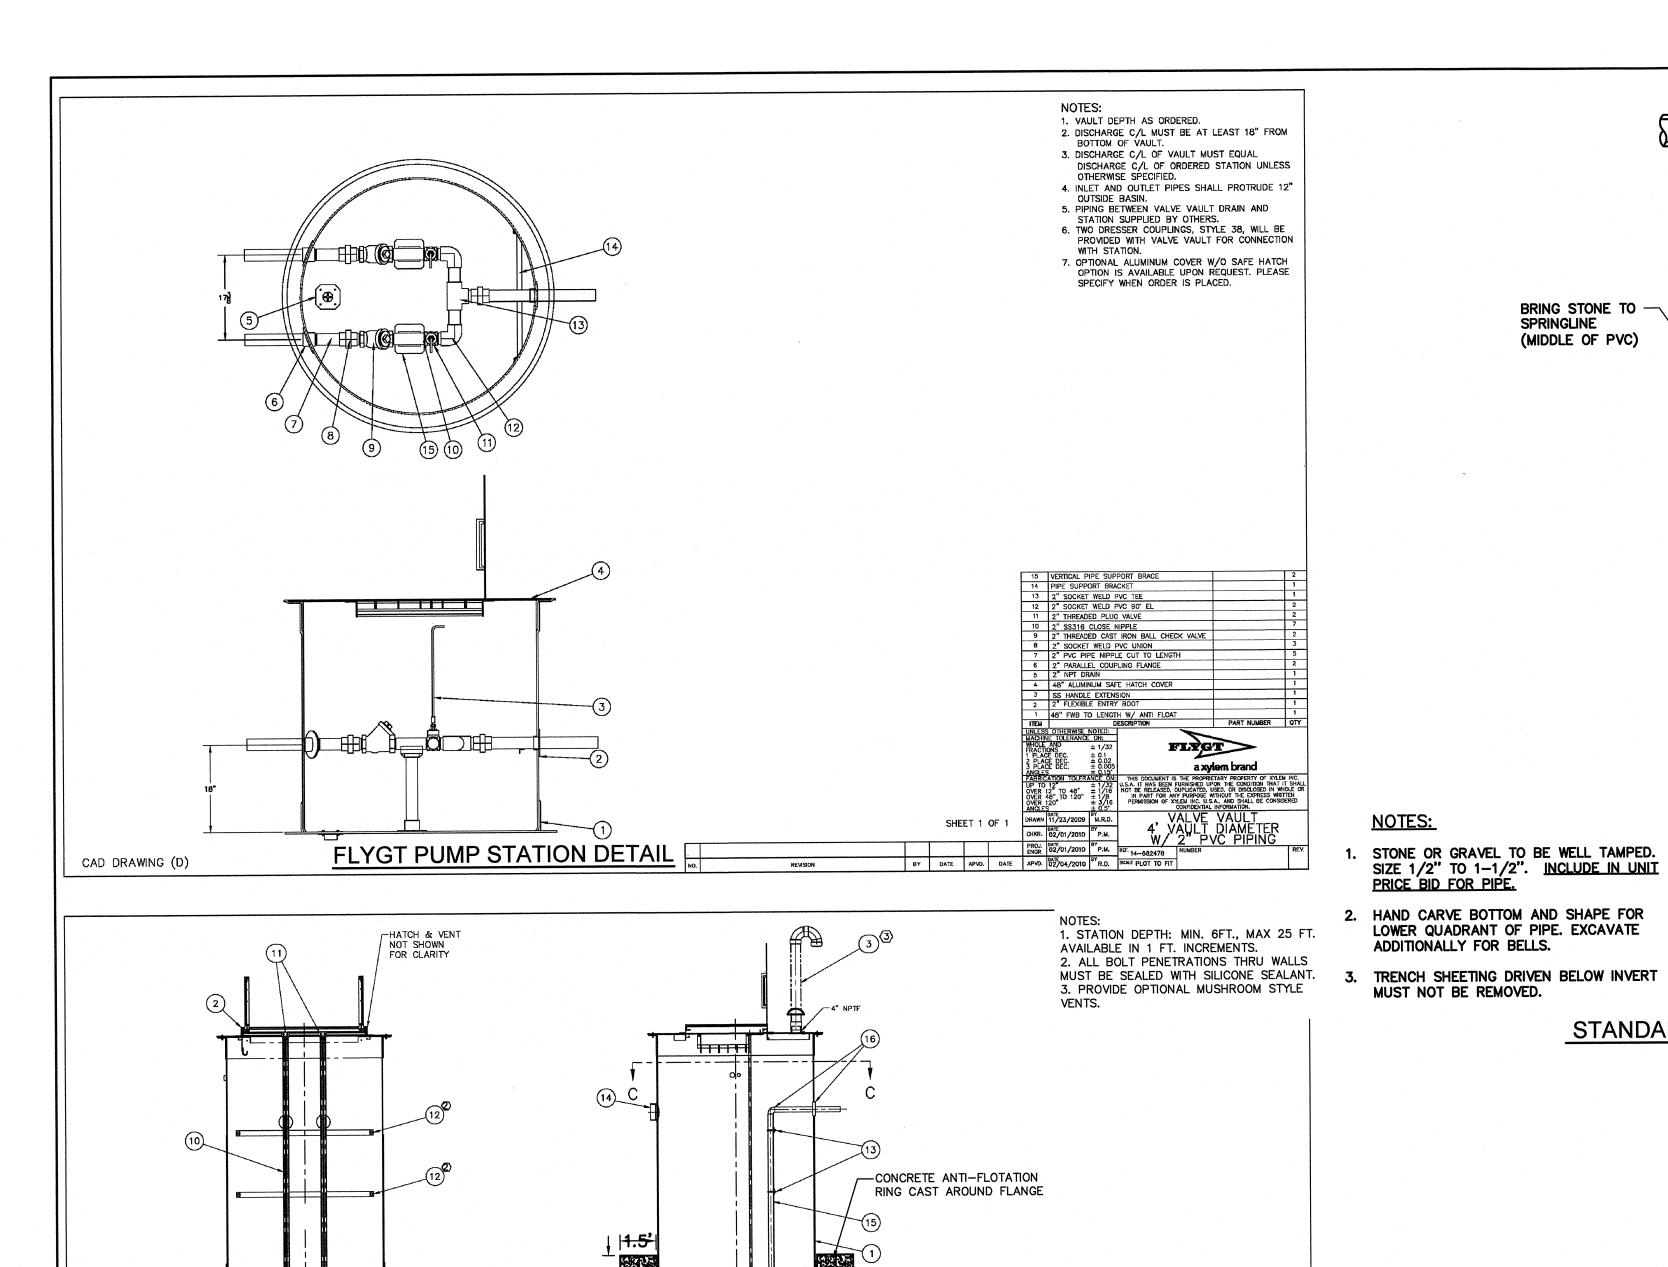


DIRECTION OF FLOW START LAYING AT LOW END AND BUILD AGAINST DIRECTION OF FLOW

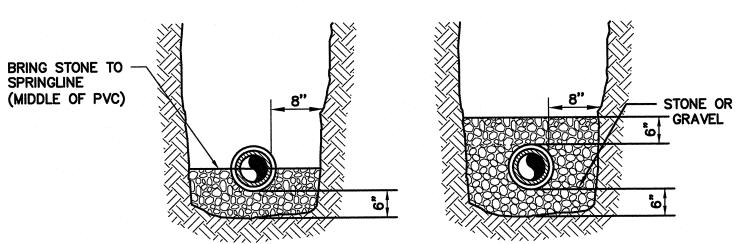

P.V.C. PIPE-NORMAL CONDITIONS

P.V.C. PIPE-WET CONDITIONS

& WET CONDITIONS

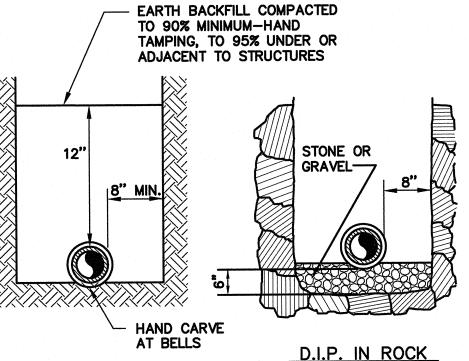

D.I.P. NORMAL

STANDARD SEWER LINE TRENCH

SPRINGLINE

LIVE OAK BANK 3

FLYGT TOP PRE-ENGINEERED FIBERGLASS PACKAGE LIFT STATION (SEE SPECIFICATIONS)

ITEM	ELEVATION
	PUMP STA.
TOP ELEV.	50.00
INFLUENT PIPE (INVERT)	46.90
HIGH WATER ALARM	46.25
START LAG PUMP	45.50
START LEAD PUMP	44.75
PUMP OFF	44.00
BOTTOM OF WETWELL	42.00
BOTTOM OF STATION SLAB	PER DETAIL
WET WELL DIAMETER	6.00

<u>ITEM</u>	<u>VALUE</u> PUMP STA.
DESIGN FLOW	25 GPM/MIN.
DESIGN HEAD (FROM PUMP CURVE)	34 FT.
REQUIRED FLOW	25 GPM/MIN.
REQUIRED HEAD (TDH)	34 FT.
VOLTAGE	460
PHASE	3 PHASE
HORSEPOWER	2 HP
RPM	3450 RPM

AN AUTO DIALER AND CONNECTION TO ON SITE BACKUP GENERATOR ARE REQUIRED. AN AUTOMATIC TRANSFER

PREFERED PUMP IS A FLYGT GRINDER PUMP STATION M-3068

SWITCH SHALL BE PROVIDED FOR GENERATOR CONNECTION.

FITPARK

FLYGT TOP PRE-ENGINEERED FIBERGLASS PACKAGE LIFT STATION (SEE SPECIFICATIONS)

<u>ITEM</u>	ELEVATION PUMP STA.
TOP ELEV.	49.50
INFLUENT PIPE (INVERT)	45.00
HIGH WATER ALARM	44.35
START LAG PUMP	43.70
START LEAD PUMP	43.05
PUMP OFF	42.40
BOTTOM OF WETWELL	40.40
BOTTOM OF STATION SLAB	PER DETAIL
WET WELL DIAMETER	6.00


DESIGN FLOW DESIGN HEAD (FROM PUMP CURVE) REQUIRED HEAD (TDH) VALUE PUMP STA. 25 GPM/MIN. 25 GPM/MIN. 48 FT. 48 FT.
DESIGN FLOW DESIGN HEAD (FROM PUMP CURVE) REQUIRED FLOW 25 GPM/MIN. 25 GPM/MIN.
REQUIRED FLOW 25 GPM/MIN.
REQUIRED FLOW 25 GPM/MIN.
DECLUDED LIEAD (TDLI) 48 FT
REQUIRED HEAD (TDH) 48 FT.
VOLTAGE 460
PHASE 3 PHASE
HORSEPOWER 2 HP
RPM 3450 RPM
PREFERED PUMP IS A FLYGT GRINDER PUMP STATION M-306

AN AUTO DIALER AND CONNECTION TO ON SITE BACKUP GENERATOR ARE REQUIRED. AN AUTOMATIC TRANSFER SWITCH SHALL BE PROVIDED FOR GENERATOR CONNECTION.


FOR PERMIT ONLY NOT FOR CONSTRUCTION

For each open utility cut of City streets, a \$325 permit shall be required from the City prior to occupancy and/or project acceptance.

WATER CAPACITY: DWQ SEWER PERMIT #: SEWER CAPACITY: SEWER SHED # AND PLANT:

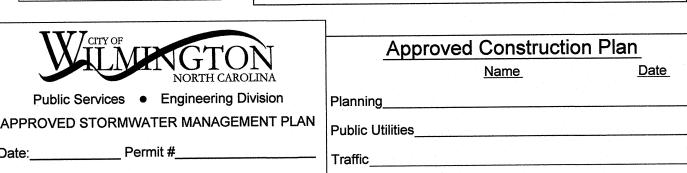

NCDENR PWSS WATER PERMIT #: SEWER TO FLOW THROUGH NEI: YES or NO (CIRCLE ONE)

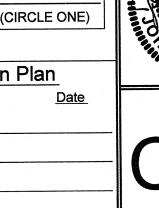

902 MARKET STREET WILMINGTON, NC 2 PHONE (910) 343-9653

Licence #C-3641

DRWN.

16169

DATE 11/3/17

JST

NKS

FLASHING ALARM LIGHT-AUDIBLE ALARM BELL-AUTO DIALER -CONTROL PANEL TRANSFER SWITCH-

TYPICAL CONTROL PANEL LAYOUT

1. THE PANEL SHALL BE MOUNTED TO ADJACENT STRUCTURE OR

THE CONTROL PANEL ENCLOSURE IS NEMA 4X FIBERGLASS.

8. THE HOA TOGGLE SWITCH AND ALARM HORN SILENCE PUSH BUTTON SHALL

10. TERMINAL STRIP SHALL BE PROVIDED FOR THE PUMP MOTORS, FLOAT

11. THE DUPLEX PANEL PROVIDED WITH AN EMERGENCY POWER AND CONNECTED 12. PANEL PROVIDED WITH A 4-CHANNEL DIALER WITH BATTERY BACK-UP

(1) KLIXON OVERLOAD

STANDARD LIFT STATION PANEL DETAIL

DUPLEX UNIT

DUPLEX CONTROL PANEL SPECIFICATION

FOR 2CS2-OMNI-240-1 2 A CIRCUIT BREAKER IS PROVIDED FOR EACH PUMP MOTOR.

AN IEC MOTOR STARTER IS PROVIDED FOR EACH PUMP MOTOR. 4. A CIRCUIT BREAKER SHALL BE PROVIDED FOR THE 120V CONTROL PANEL. AN ELECTRONIC ALTERNATOR ALTERNATES PUMPS UPON SUCCESSIVE CYCLE.

6. HIGH LEVEL ALARM INDICATION IS PROVIDED BY NEMA 4X ALARM LIGHT WITH A RED POLYCARABONATE GLOBE IS AFFIXED TO THE TOP OF THE CONTROL ENCLOSURE; AND AN ALARM HORN AFFIXED TO THE BOTTOM OF THE ENCLOSURE WITH A SILENCE PUSH BUTTON AFFIXED TO THE ENCLOSURE DOOR.

7. EACH PUMP SHALL HAVE A HAND/OFF/AUTO SELECTOR SWITCH.

BE MOUNTED ON A BRACKET ATTACHED TO THE ENCLOSURE BACK PANEL. 9. THE PUMPS SHALL OPERATE OFF FLOAT SWITCHES. (4) FLOAT SWITCHES SHALL BE PROVIDED.

SWITCHES, AND POWER SUPPLY TO THE CONTROL PANEL. TO ON SITE BACKUP GENERATOR, 60 AMP, 240/1/60 - 3 WIRE.

FLYGT PUMP STATION DETAIL

VIEW B-B

(2) ALUMINUM BACK PANEL

(4) PUMP CIRCUIT FUSE (5) CONTROL CIRCUIT FUSE

(6) ALARM CIRCUIT FUSE

7 START WINDING RELAY(S)

(B) STARTING CAPACITOR(S)

(9) RUNNING CAPACITOR(S)

(1) HAND-OFF-AUTO SWITCH

VIEW A-A

14 HUB

13 U-BOLT §-16 00 2-½ 2" PIPE

12 BRACING, DISCHARGE PIPE

11 UPPER GUIDE BAR KIT, 3/4"

10 GUIDE BAR, 3/4", 316 SST

ASHER, 1 ID, 12 OD, GENERAL PURPOSE, 316 SST

16 PIPING KIT, 2"

15 PIPE, 2", SCH 80, PVC 40, SST

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(12) PUMP ROAD LIGHT

(3) SEAL LEAK LIGHT
Only on units with detector 14) TERMINAL BLOCKS

(15) GROUND LUG(S)

FLASHING ALARM LIGHT
Mounted on top of
enclosure (red) (7) SOLID STATE FLASHER


(18) OVERRIDE RELAY
In event of first pump
failure (duplex only) ALTERNATOR RELAY
Solid state (duplex only)

20 AUDIBLE ALARM BELL

POWER PACK. 13. PROVIDE AN AUTOMATIC TRANSFER SWITCH AND CONNECT TO ON

SITE BACKUP GENERATOR. 14. PROVIDE LOCKING ENCLOSURE FOR CONTROL PANEL.

MOUNTED FREE STANDING ON PRESSURE TREATED POST.

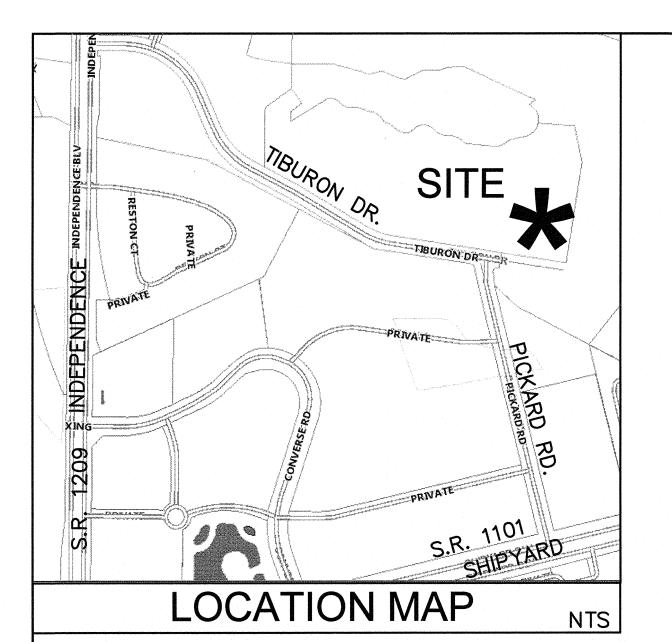

LIVE OAK BANKING COMPANY3/FITPARK

WILMINGTON, NC NEW HANOVER COUNTY


OWNER/DEVELOPER W. LEE WILLIAMS **EXECUTIVE VICE PRESIDENT** LIVE OAK BANCSHARES, INC. 1741 TIBURON DRIVE WILMINGTON, NC 28403 910-796-1647 910-790-5868

SITE SURVEYOR:

HANOVER DESIGN SERVICES, P.A. LAND SURVEYORS ENGINEERS LAND PLANNERS

> 1123 FLORAL PARKWAY WILMINGTON, N.C. 28403 PHONE: 910 343-8002 FAX: 910 343-9941



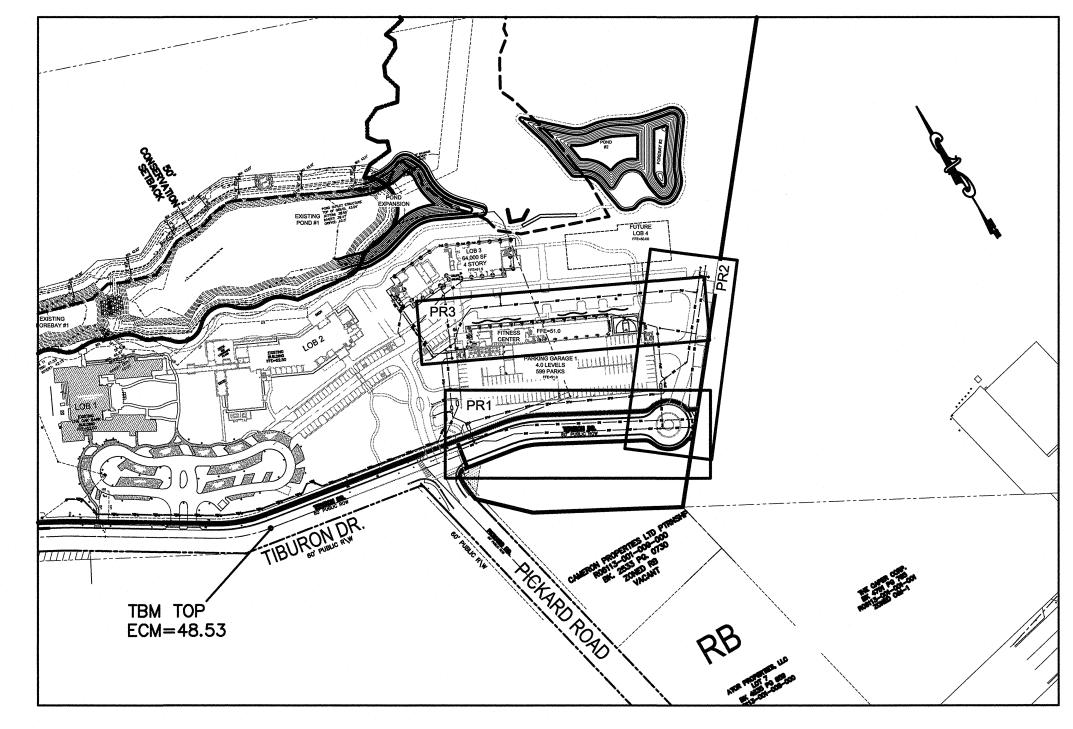

SCALE: 1" = 200'

Public Services • Engineering Division APPROVED STORMWATER MANAGEMENT PLAN NCDENR PWSS WATER PERMIT #: WATER CAPACITY: GPD SEWER CAPACITY: SEWER SHED # AND PLANT: SEWER TO FLOW THROUGH NEI: YES or NO (CIRCLE ONE)

For each open utility cut of

City streets, a \$325 permit

shall be required from the

City prior to occupancy

and/or project acceptance.

Approved Construction Plan

INDEX OF SHEETS

WATER/SEWER/ROAD PLAN AND PROFILE LINE 1

SANITARY SEWER STANDARD DETAILS SSD-3: SANITARY SEWER STANDARD DETAILS

PUBLIC WATER:

546 LF 8" WATER LINE 30 LF 6" WATER LINE

PUBLIC SEWER: 505 LF 8" SEWER LINE

PRIVATE WATER:

1,078 LF 8" WATER LINE 490 LF 6" WATER LINE 241 LF 3" WATER LINE

GERVICES

PRIVATE SEWER: 293 LF 8" SANITARY SEWER 652 LF 6" SANITARY SEWER SETTICES 2,463 LF 2" SEWER FORCEMAIN LECTICES

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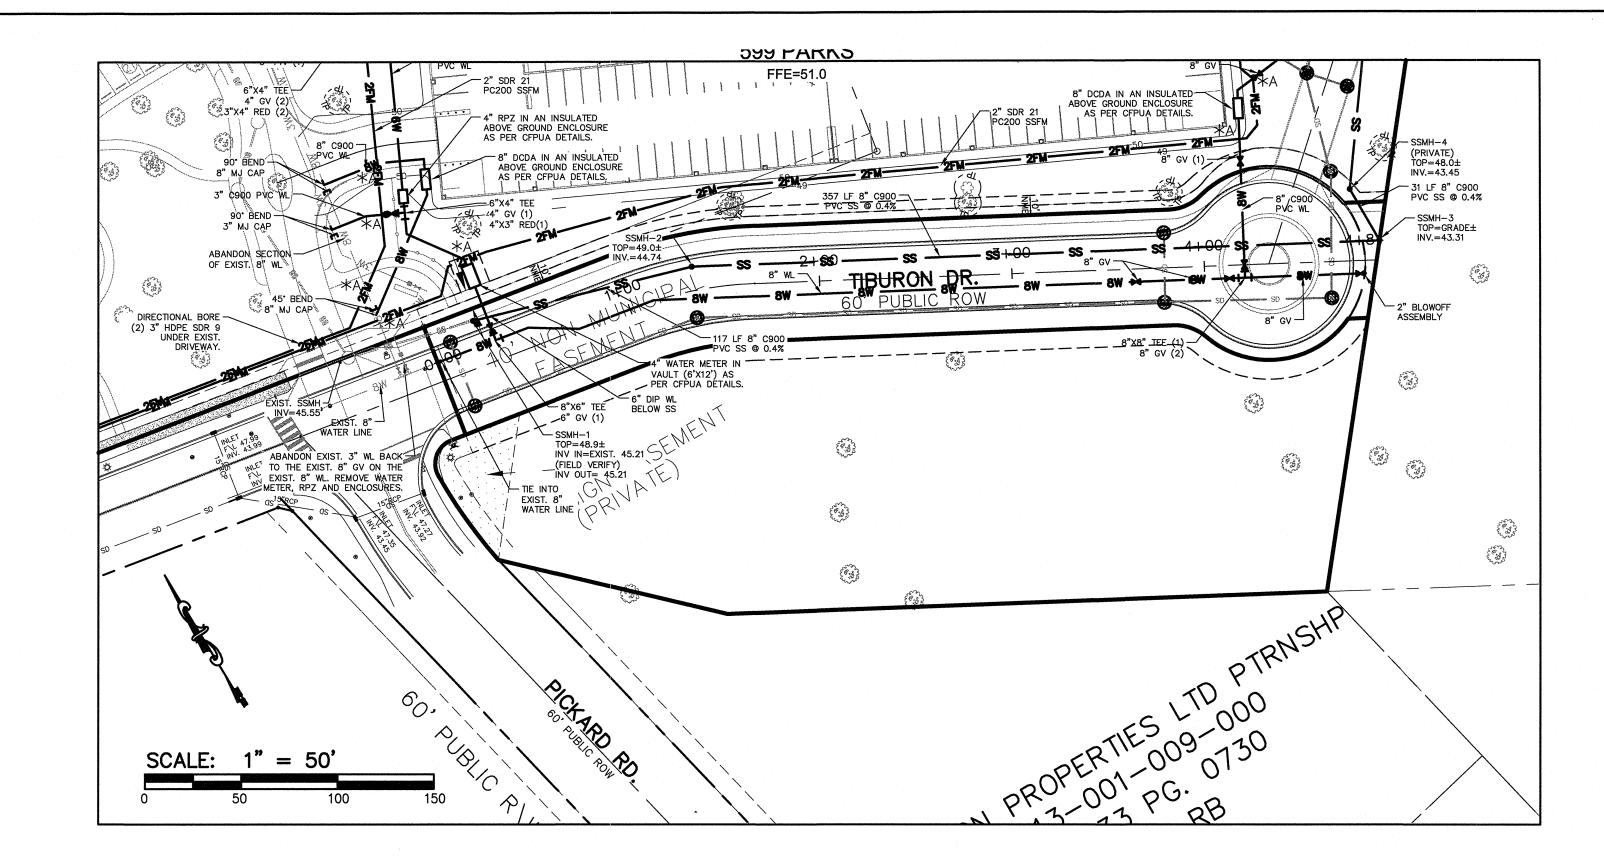
NORRIS & TUNSTALL


— CONSULTING ENGINEERS P.C. —


902 MARKET STREET WILMINGTON, NC 28401 PHONE (910) 343-9653

1429 ASH-LITTLE RIVER RD. NW ASH, NC 28420 PHONE (910) 287-5900

16169



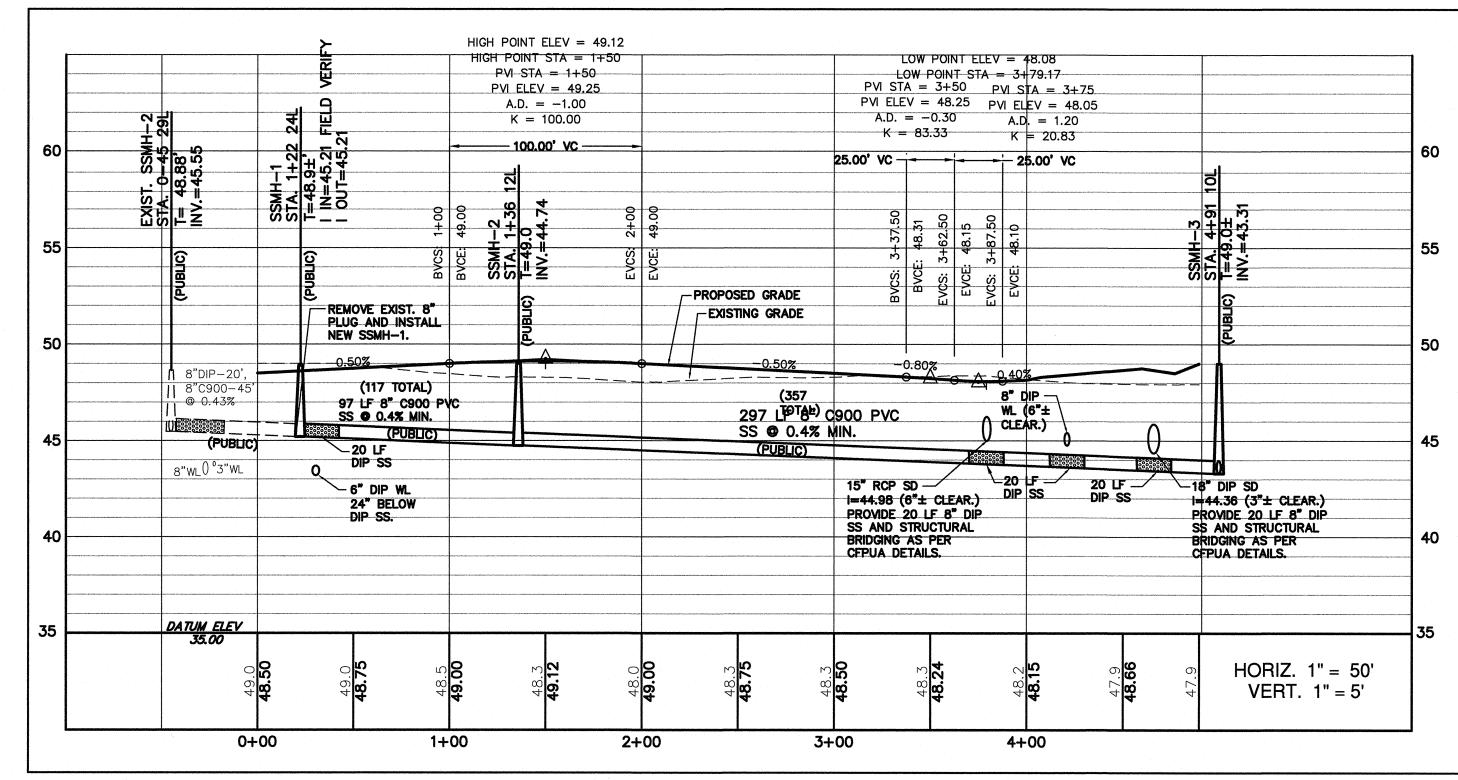

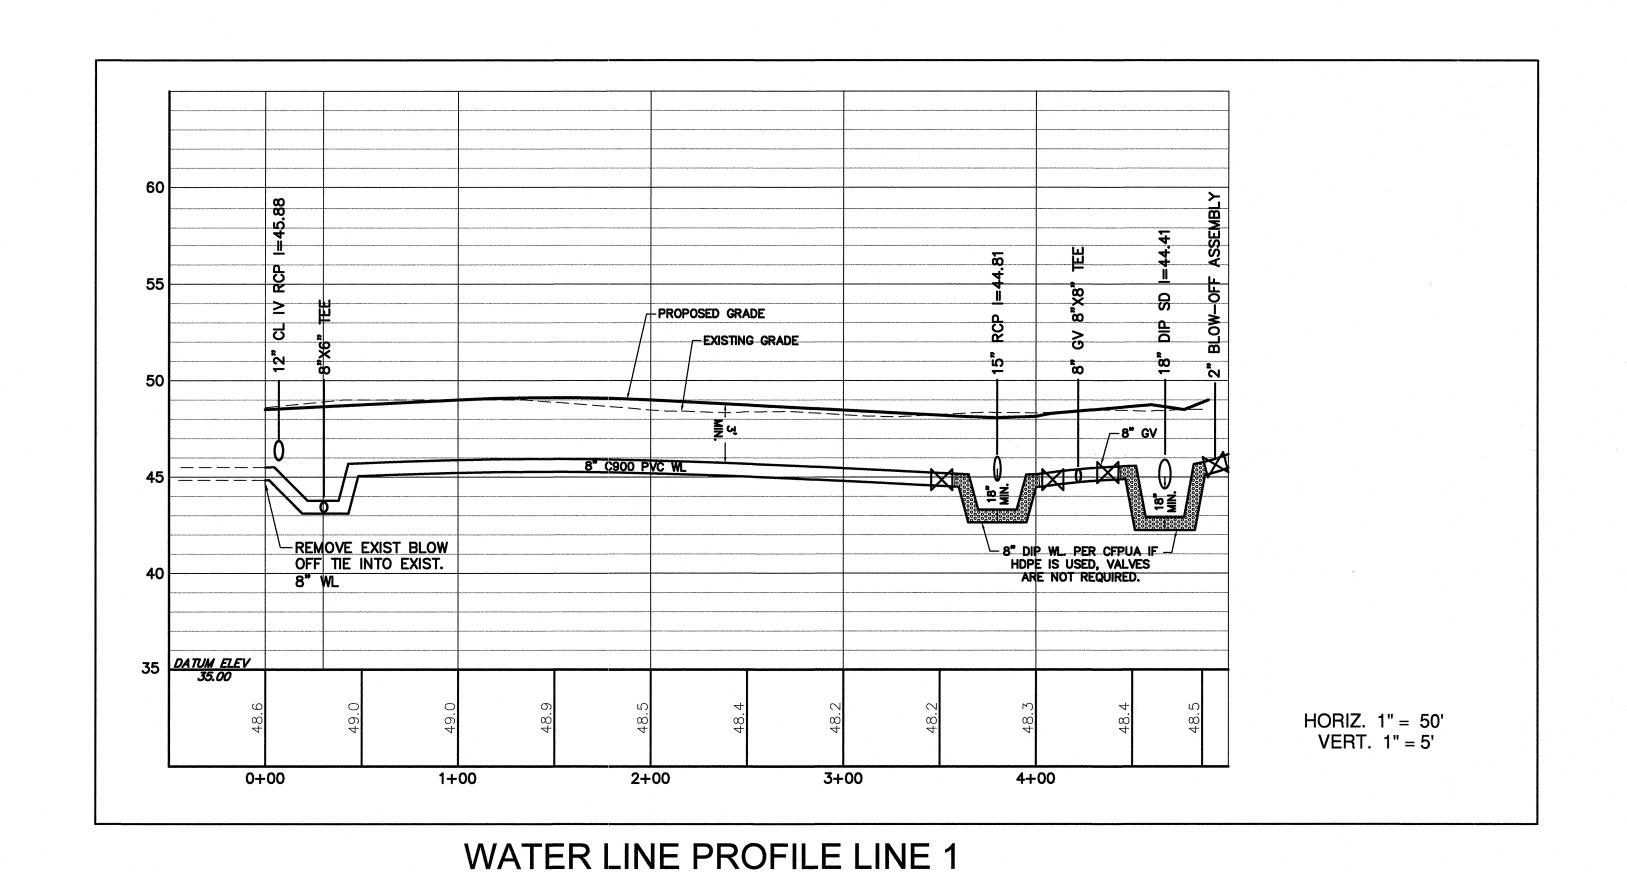

SANITARY SEWER AND ROAD PROFILE LINE 1

1. SEWER GUARDS REQUIRED AT ALL MANHOLES. STAINLESS STEEL SEWER GUARDS REQUIRED AT MANHOLES LOCATED IN TRAFFIC AREAS. 2. WATER AND SEWER SERVICES SHALL BE PERPENDICULAR TO MAIN AND TERMINATE AT RIGHT-OF-WAY LINE. SEWER SERVICES IN CUL-DE-SACS ARE REQUIRED TO BE PERPENDICULAR, OR MUST ORIGINATE IN END OF LINE MANHOLE AND TERMINATE AT RIGHT-OF-WAY LINE. 3. ALL SERVICES TYING INTO DUCTILE IRON MAINS SHALL BE CONSTRUCTED OF CLASS 50 DIP WITH PROTECTO 401 CERAMIC EPOXY LINING.

CFPUA STANDARD SEWER NOTES:

4. MINIMUM 10' UTILITIES EASEMENT PROVIDED ALONG THE FRONTAGE OF ALL LOTS AND AS SHOWN FOR NEW

DEVELOPMENTS. 5. NO FLEXIBLE COUPLINGS SHALL BE USED.
6. ALL STAINLESS STEEL FASTENERS SHALL BE 316. 7. CLEANOUTS SHALL BE LOCATED A MINIMUM OF 12 FEET FROM ALL PROPERTY CORNERS. WATER METER BOXES ARE TO BE A MINIMUM OF 5 FEET FROM THE PROPERTY CORNER.

APPROVED STORMWATER MANAGEMENT PLAN

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REVISIONS

Public Utility Authority

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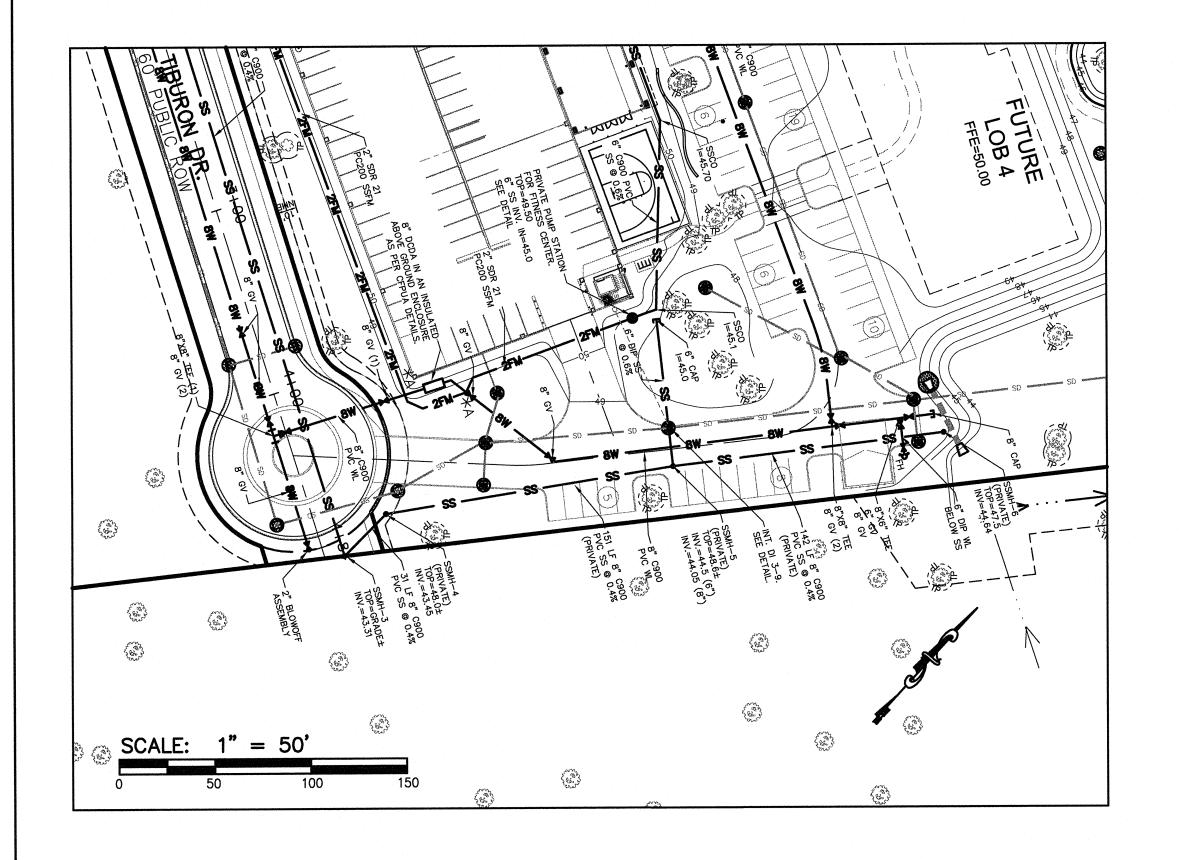
NORRIS & TUNSTALL (11/3/17 CONSULTING ENGINEERS P.C. 902 MARKET STREET 1429 ASH-LITTLE RIVER RD. NW SCALE:1" = 50' WILMINGTON, NC 28401 ASH, NC 28420 PHONE (910) 343-9653 Licence #C-3641 PHONE (910) 287-5900


LIVE OAK BANKING COMPANY 3/FITPARK SANITARY SEWER AND ROAD PLAN & PROFILE


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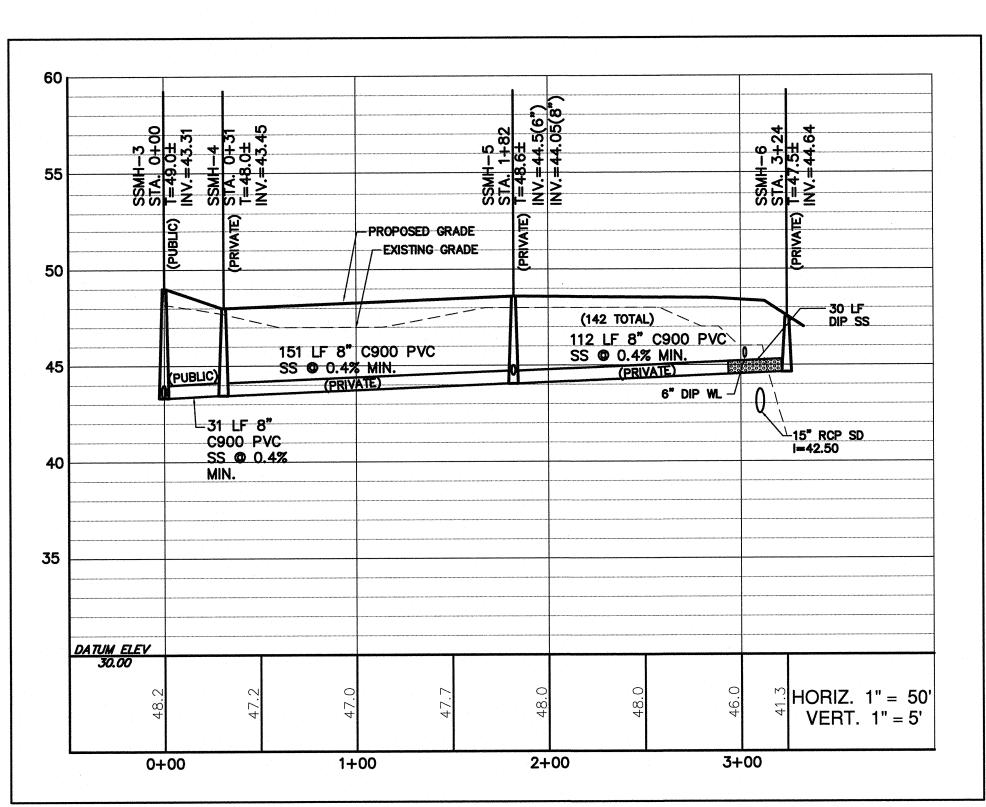
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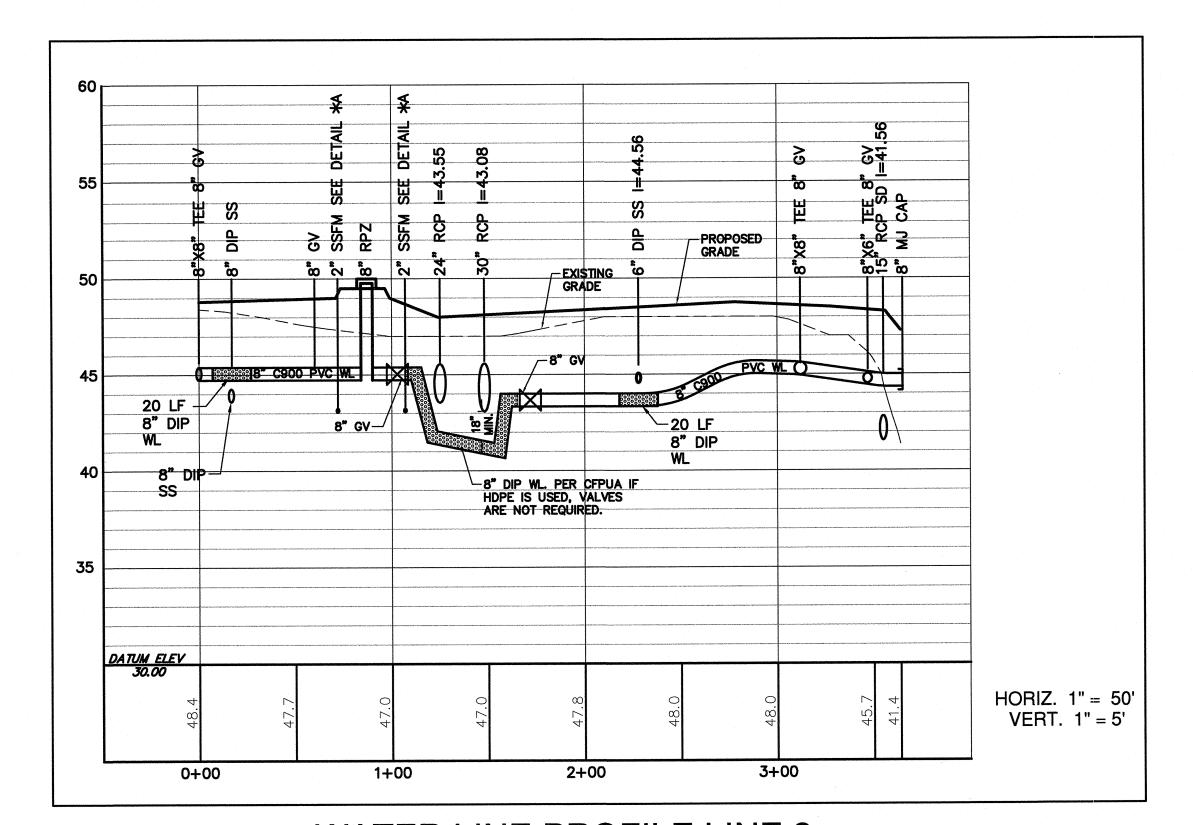





INTERFERENCE DROP INLET DETAIL

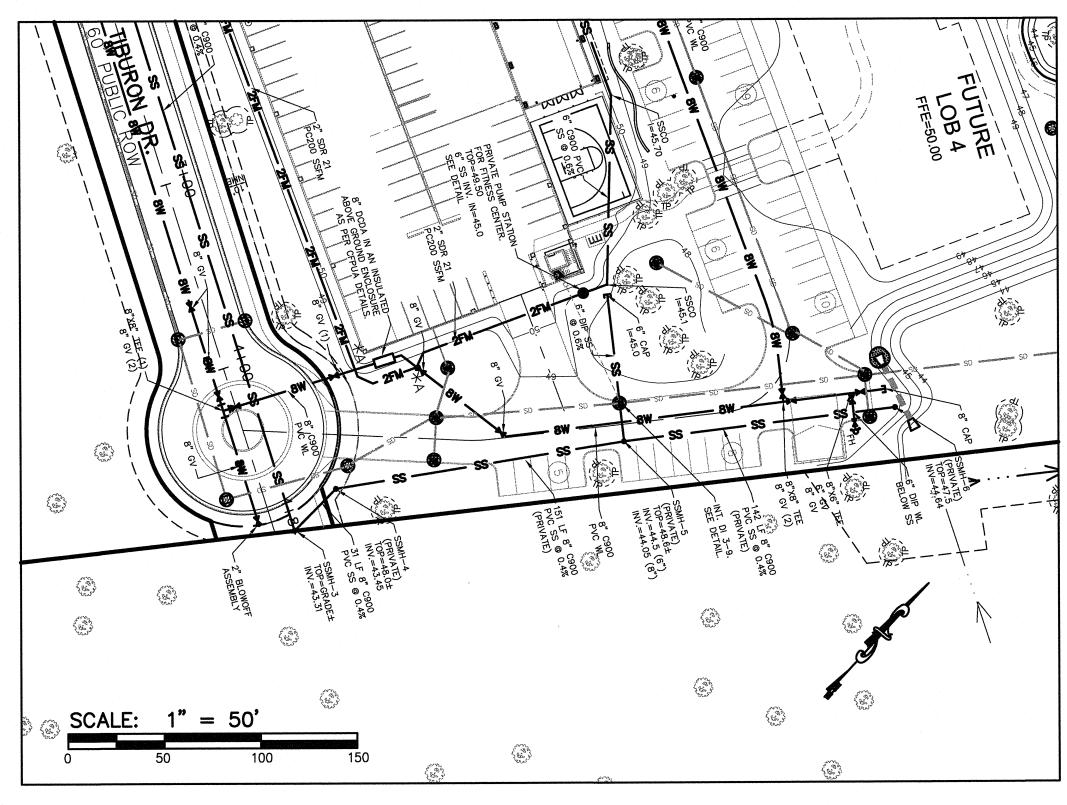

SANITARY SEWER PROFILE LINE 2

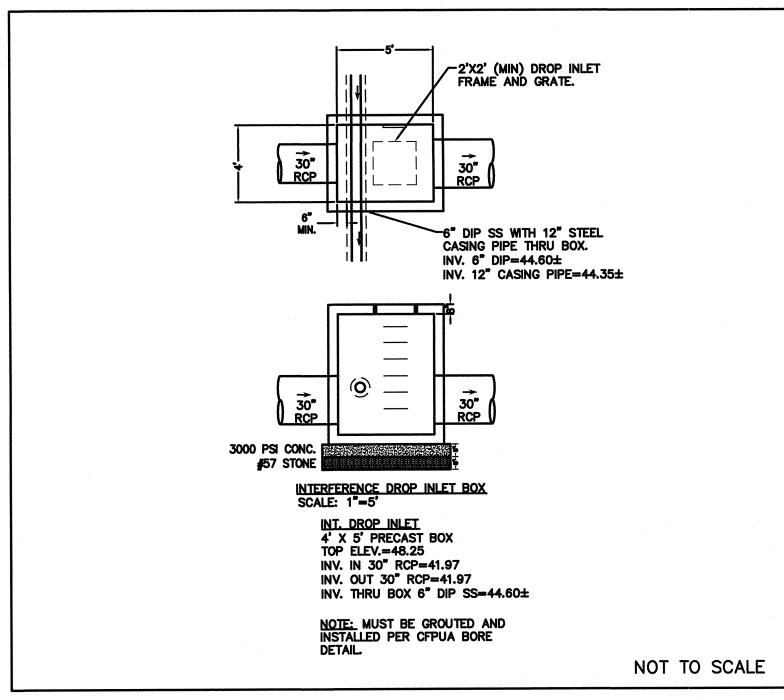

WATER LINE PROFILE LINE 2

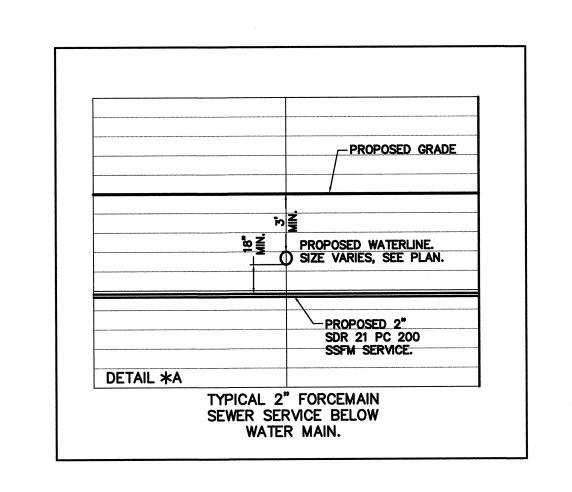

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PROJECT NO:

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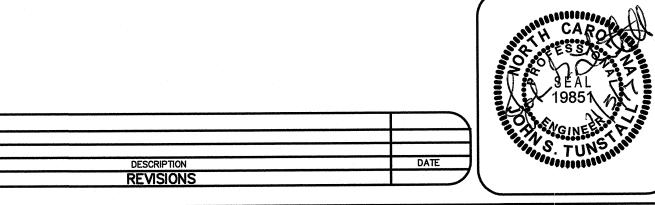
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Public Services • Engineering Division APPROVED STORMWATER MANAGEMENT PLAN GPD

Approved Construction Plan <u>Date</u>






NORRIS & TUNSTALL (11/3/17 CONSULTING ENGINEERS P.C. 902 MARKET STREET 1429 ASH-LITTLE RIVER RD. NW WILMINGTON, NC 28401 ASH, NC 28420 PHONE (910) 343-9653 Licence #C-3641 PHONE (910) 287-5900


WATER LINE

LIVE OAK BANKING COMPANY 3/FITPARK PLAN & PROFILE


CORNER.


SHEET NO: SCALE:1" = 50'

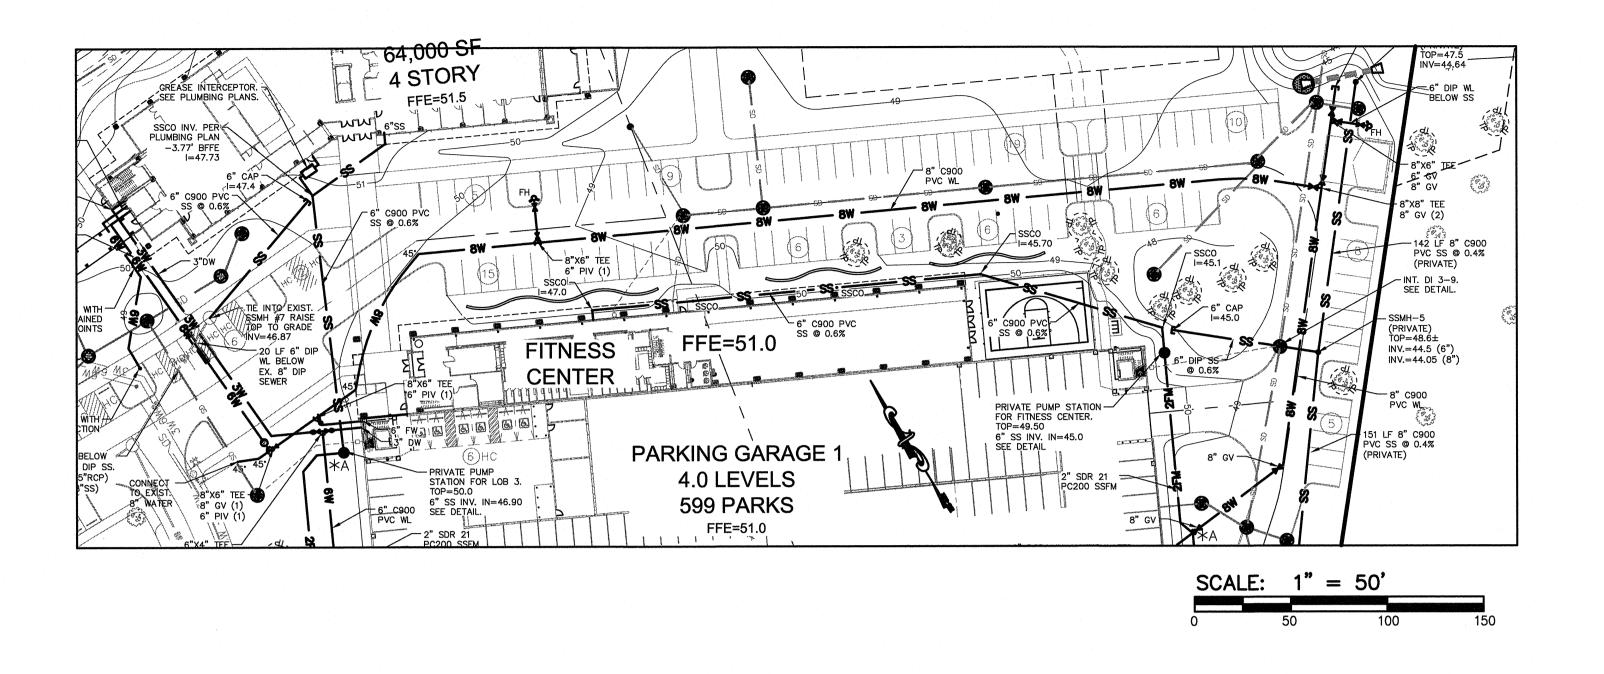

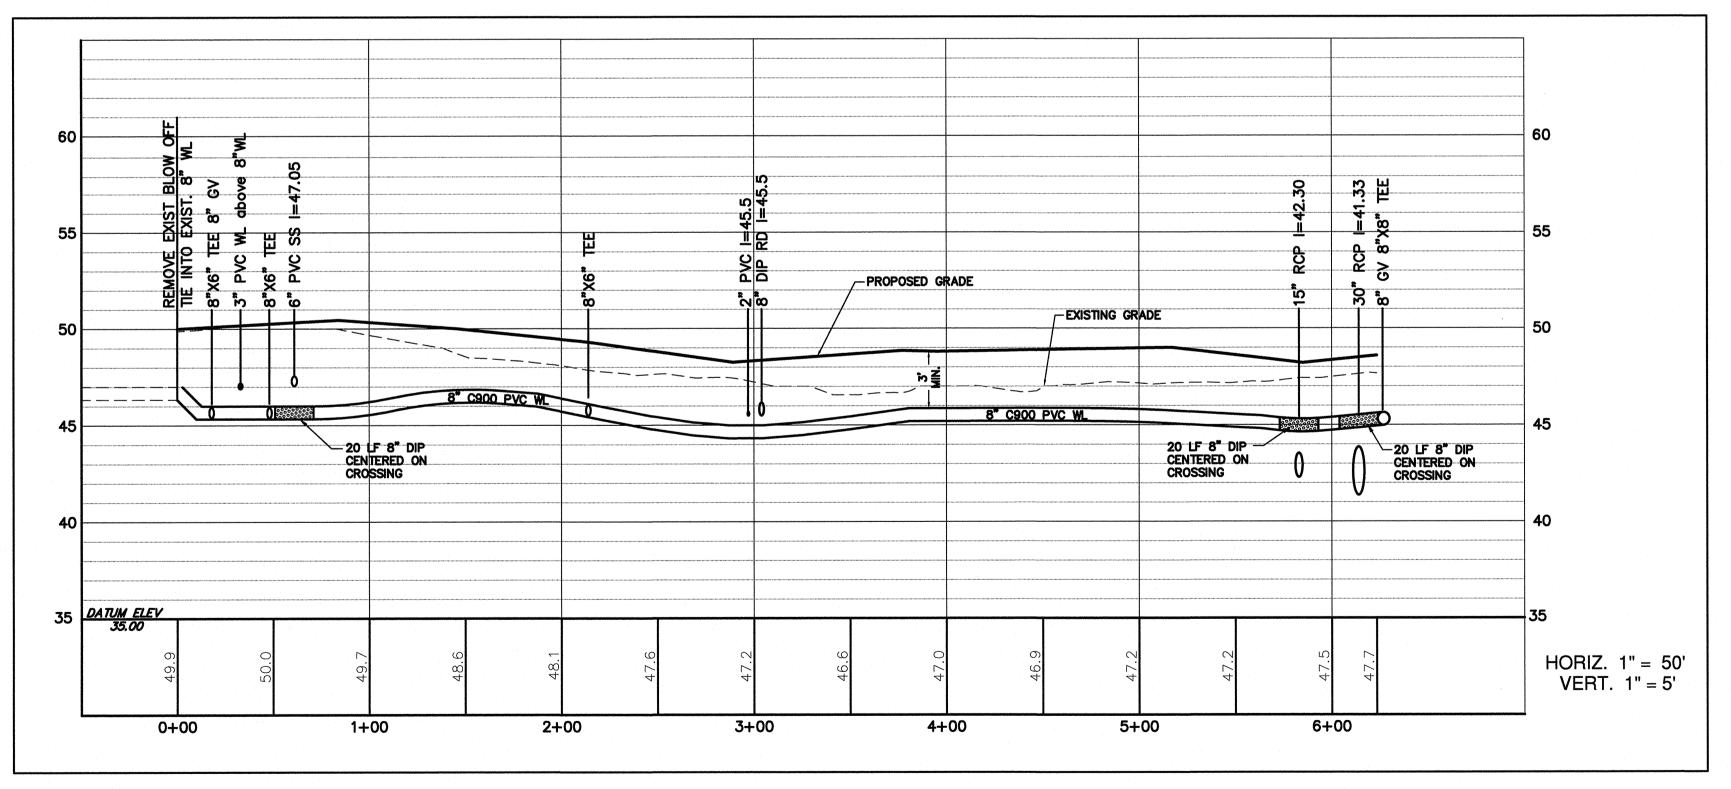


WATER LINE PROFILE LINE 3

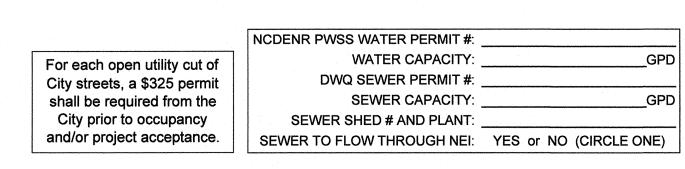

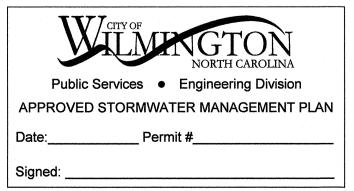

Appro	Approved Construction Plan				
	Name		<u>Date</u>		
lanning					
raffic					
re					
			-		

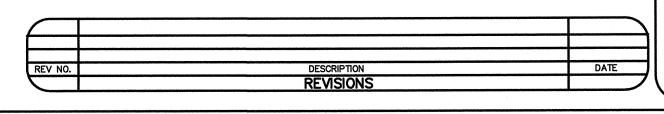

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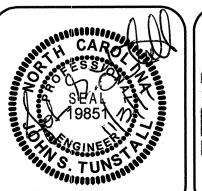
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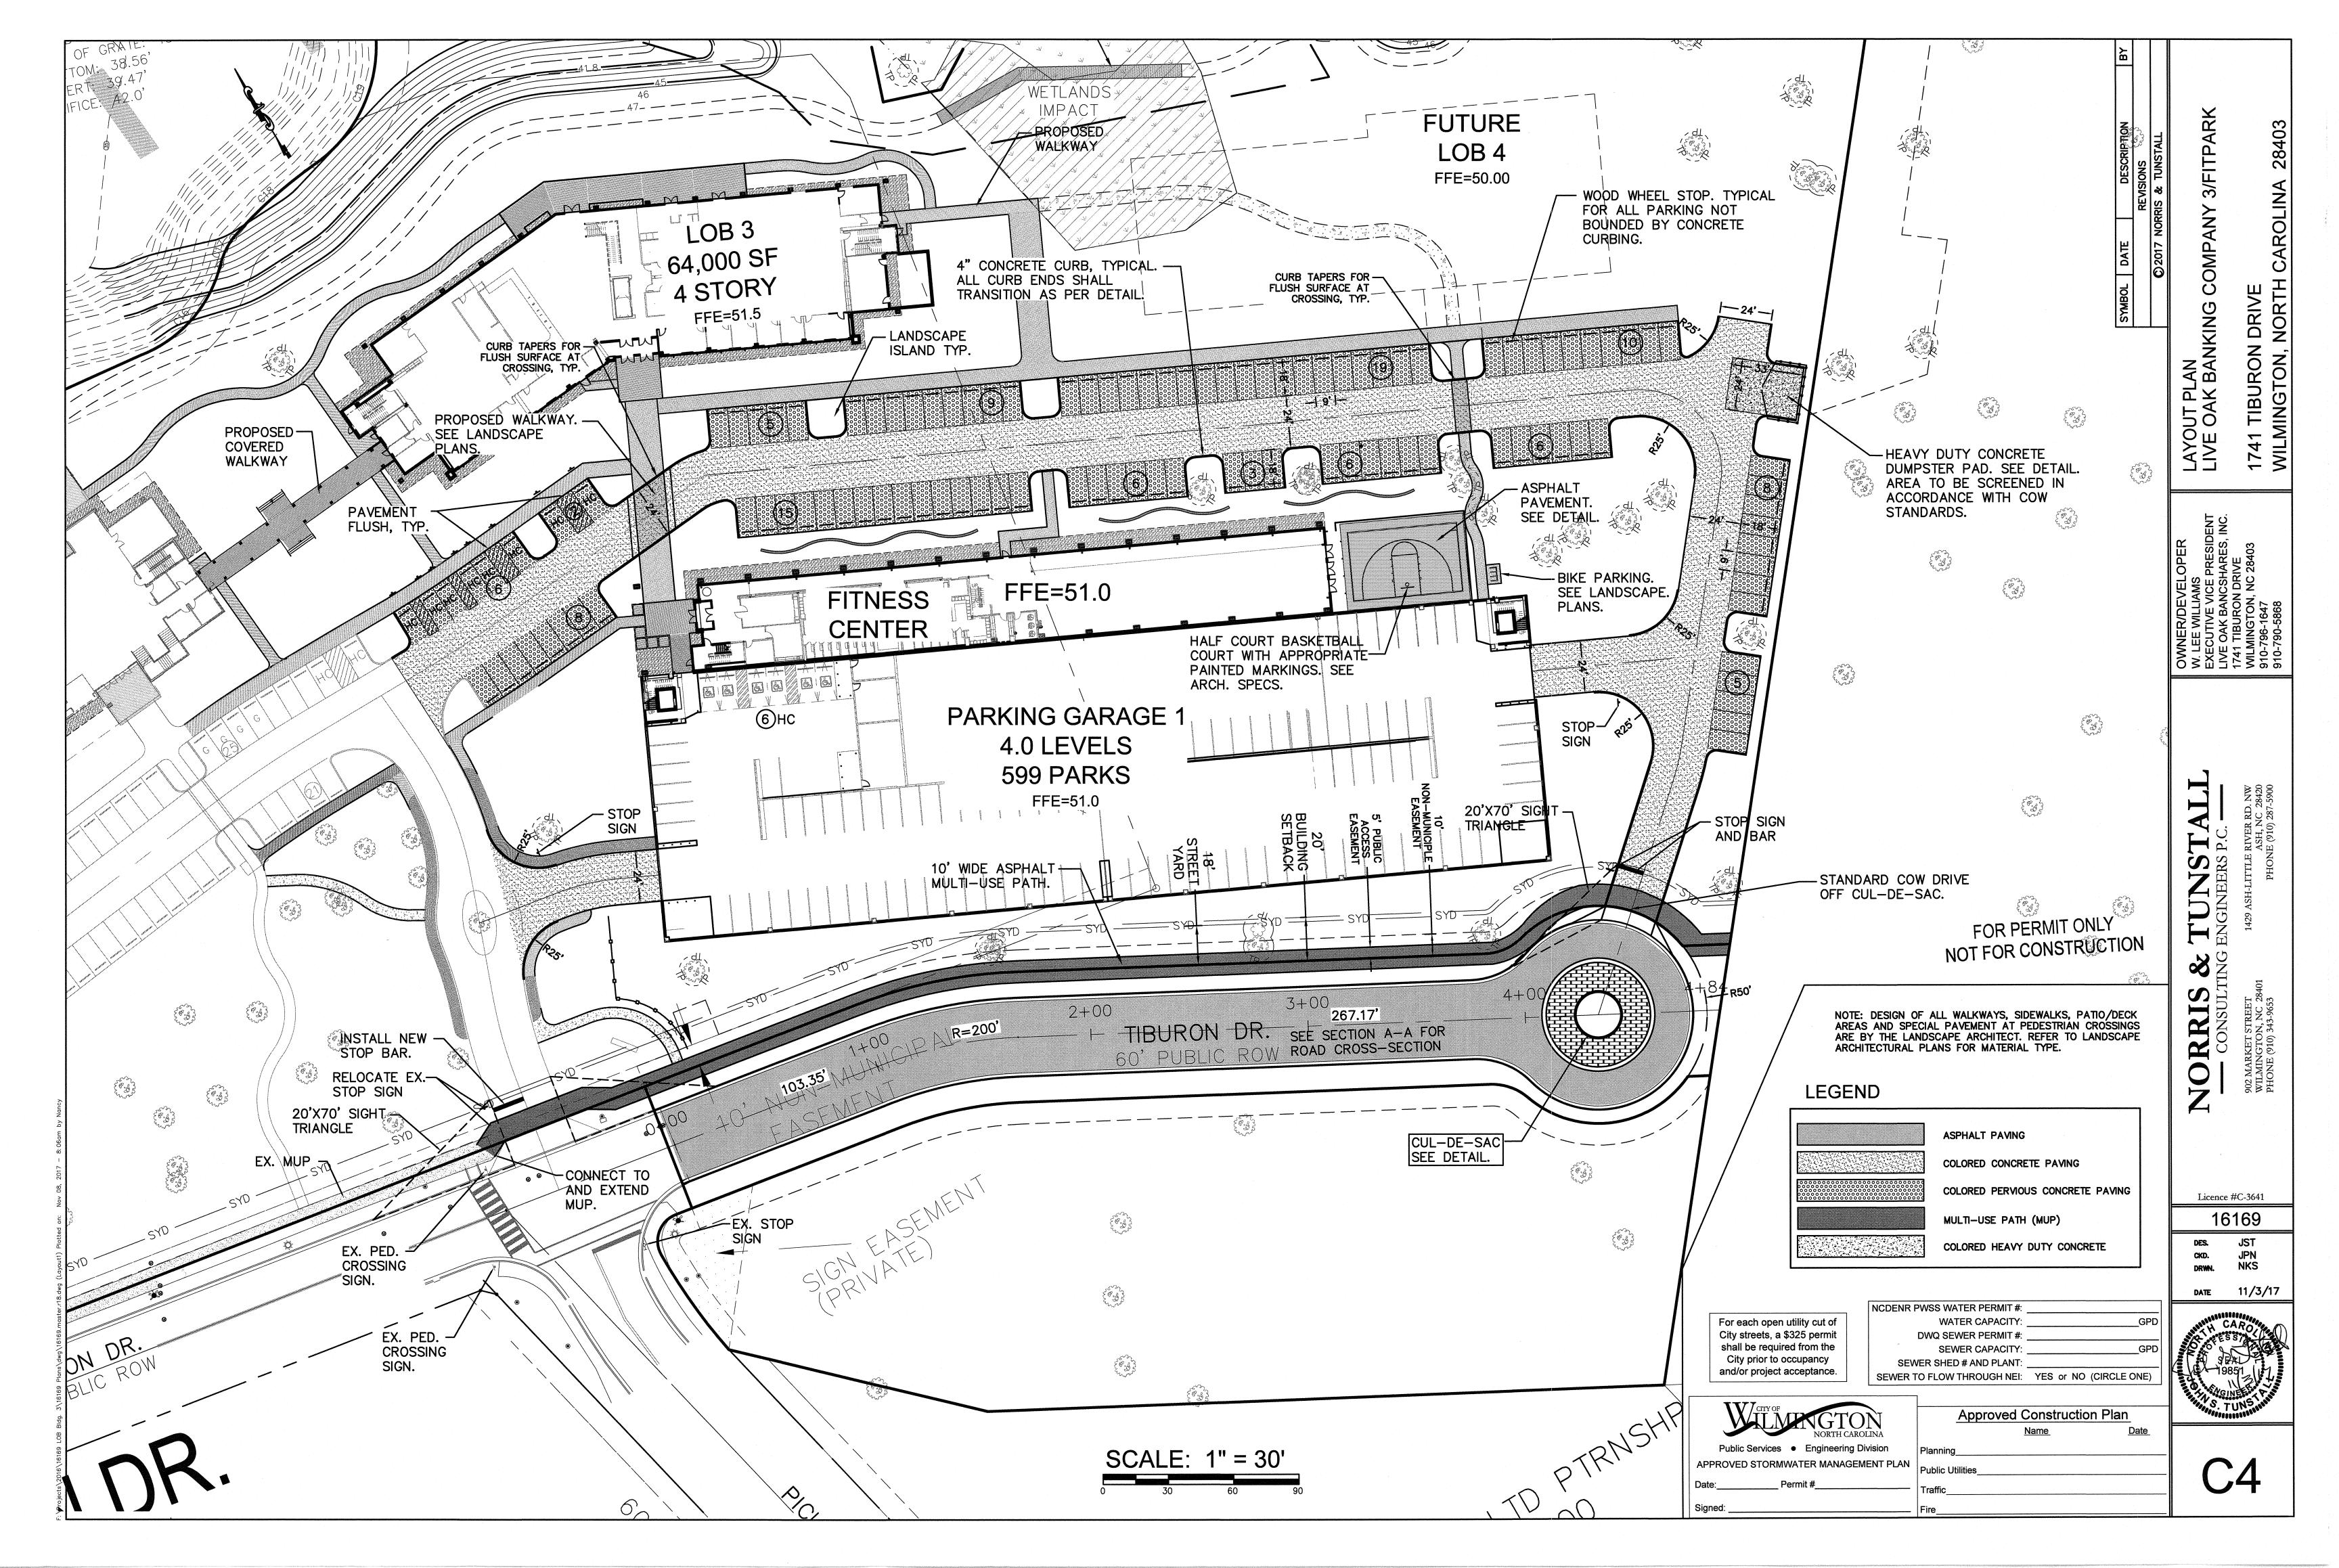



NORRIS & TUNSTALL 11/3/17 CONSULTING ENGINEERS P.C.


WILMINGTON, NC 28401 ASH, NC 28420 PHONE (910) 343-9653 Licence #C-3641 PHONE (910) 287-5900

LIVE OAK BANKING COMPANY 3/FITPARK WATER LINE PLAN & PROFILE

SHEET NO:



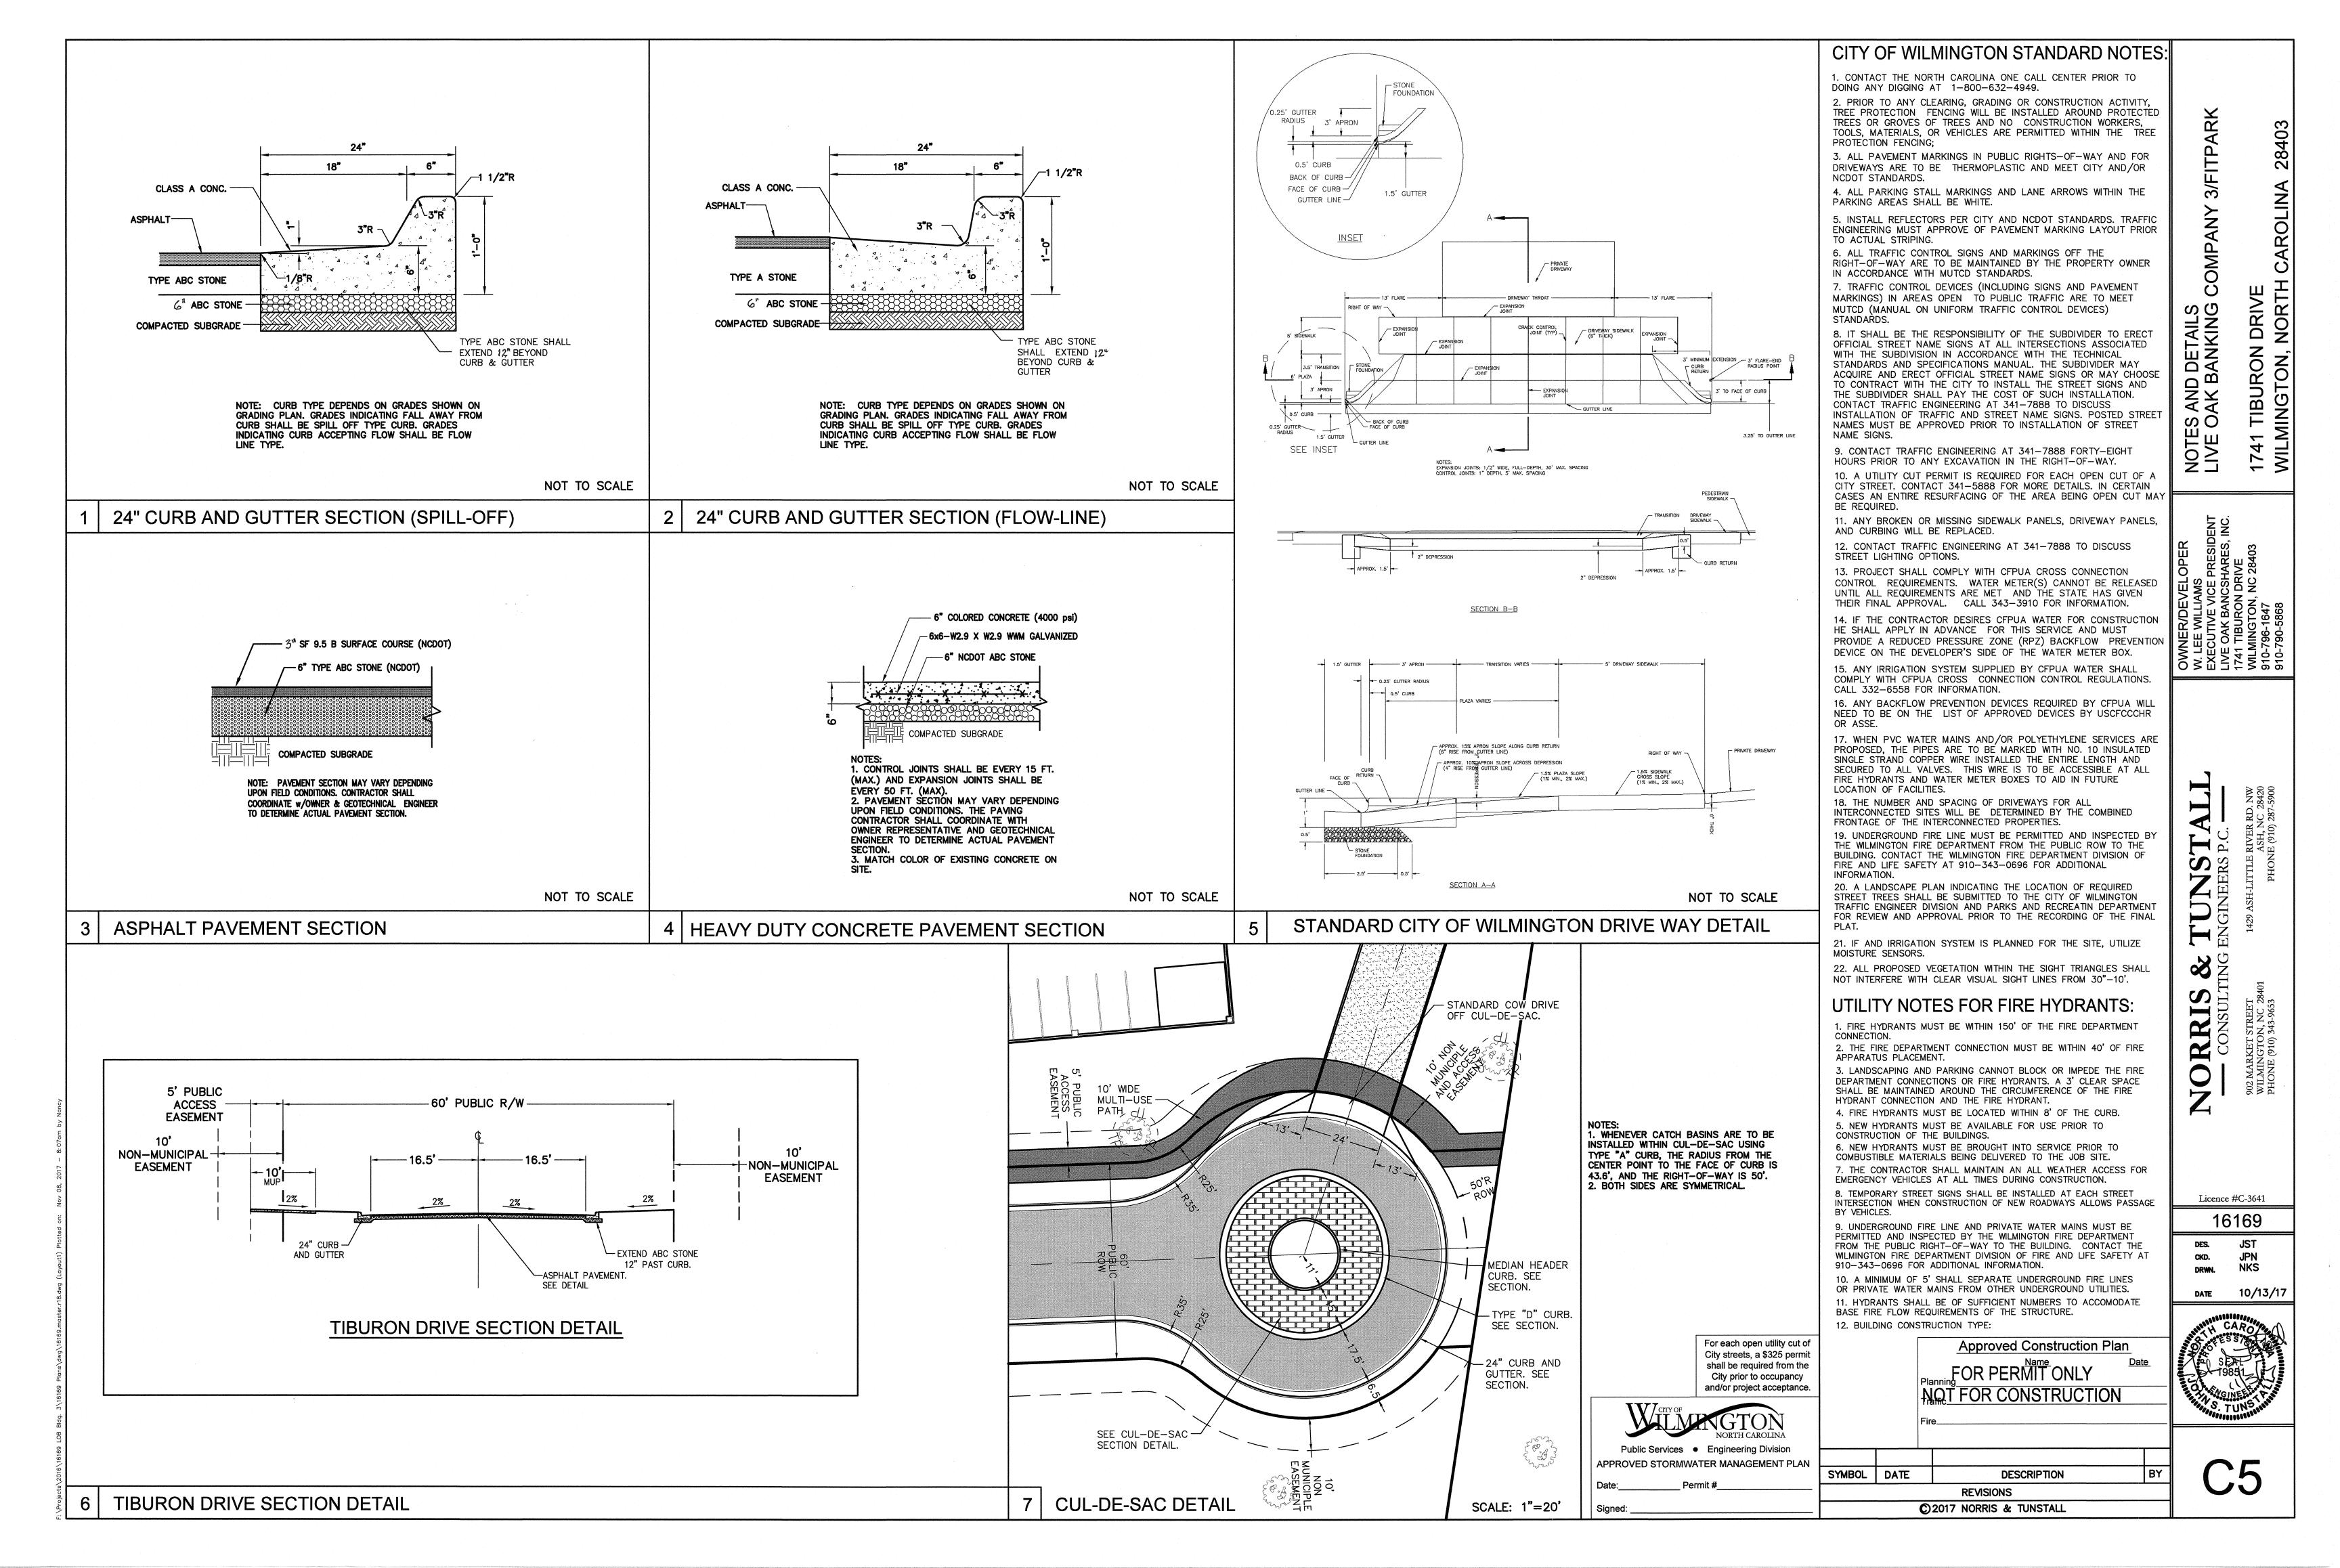

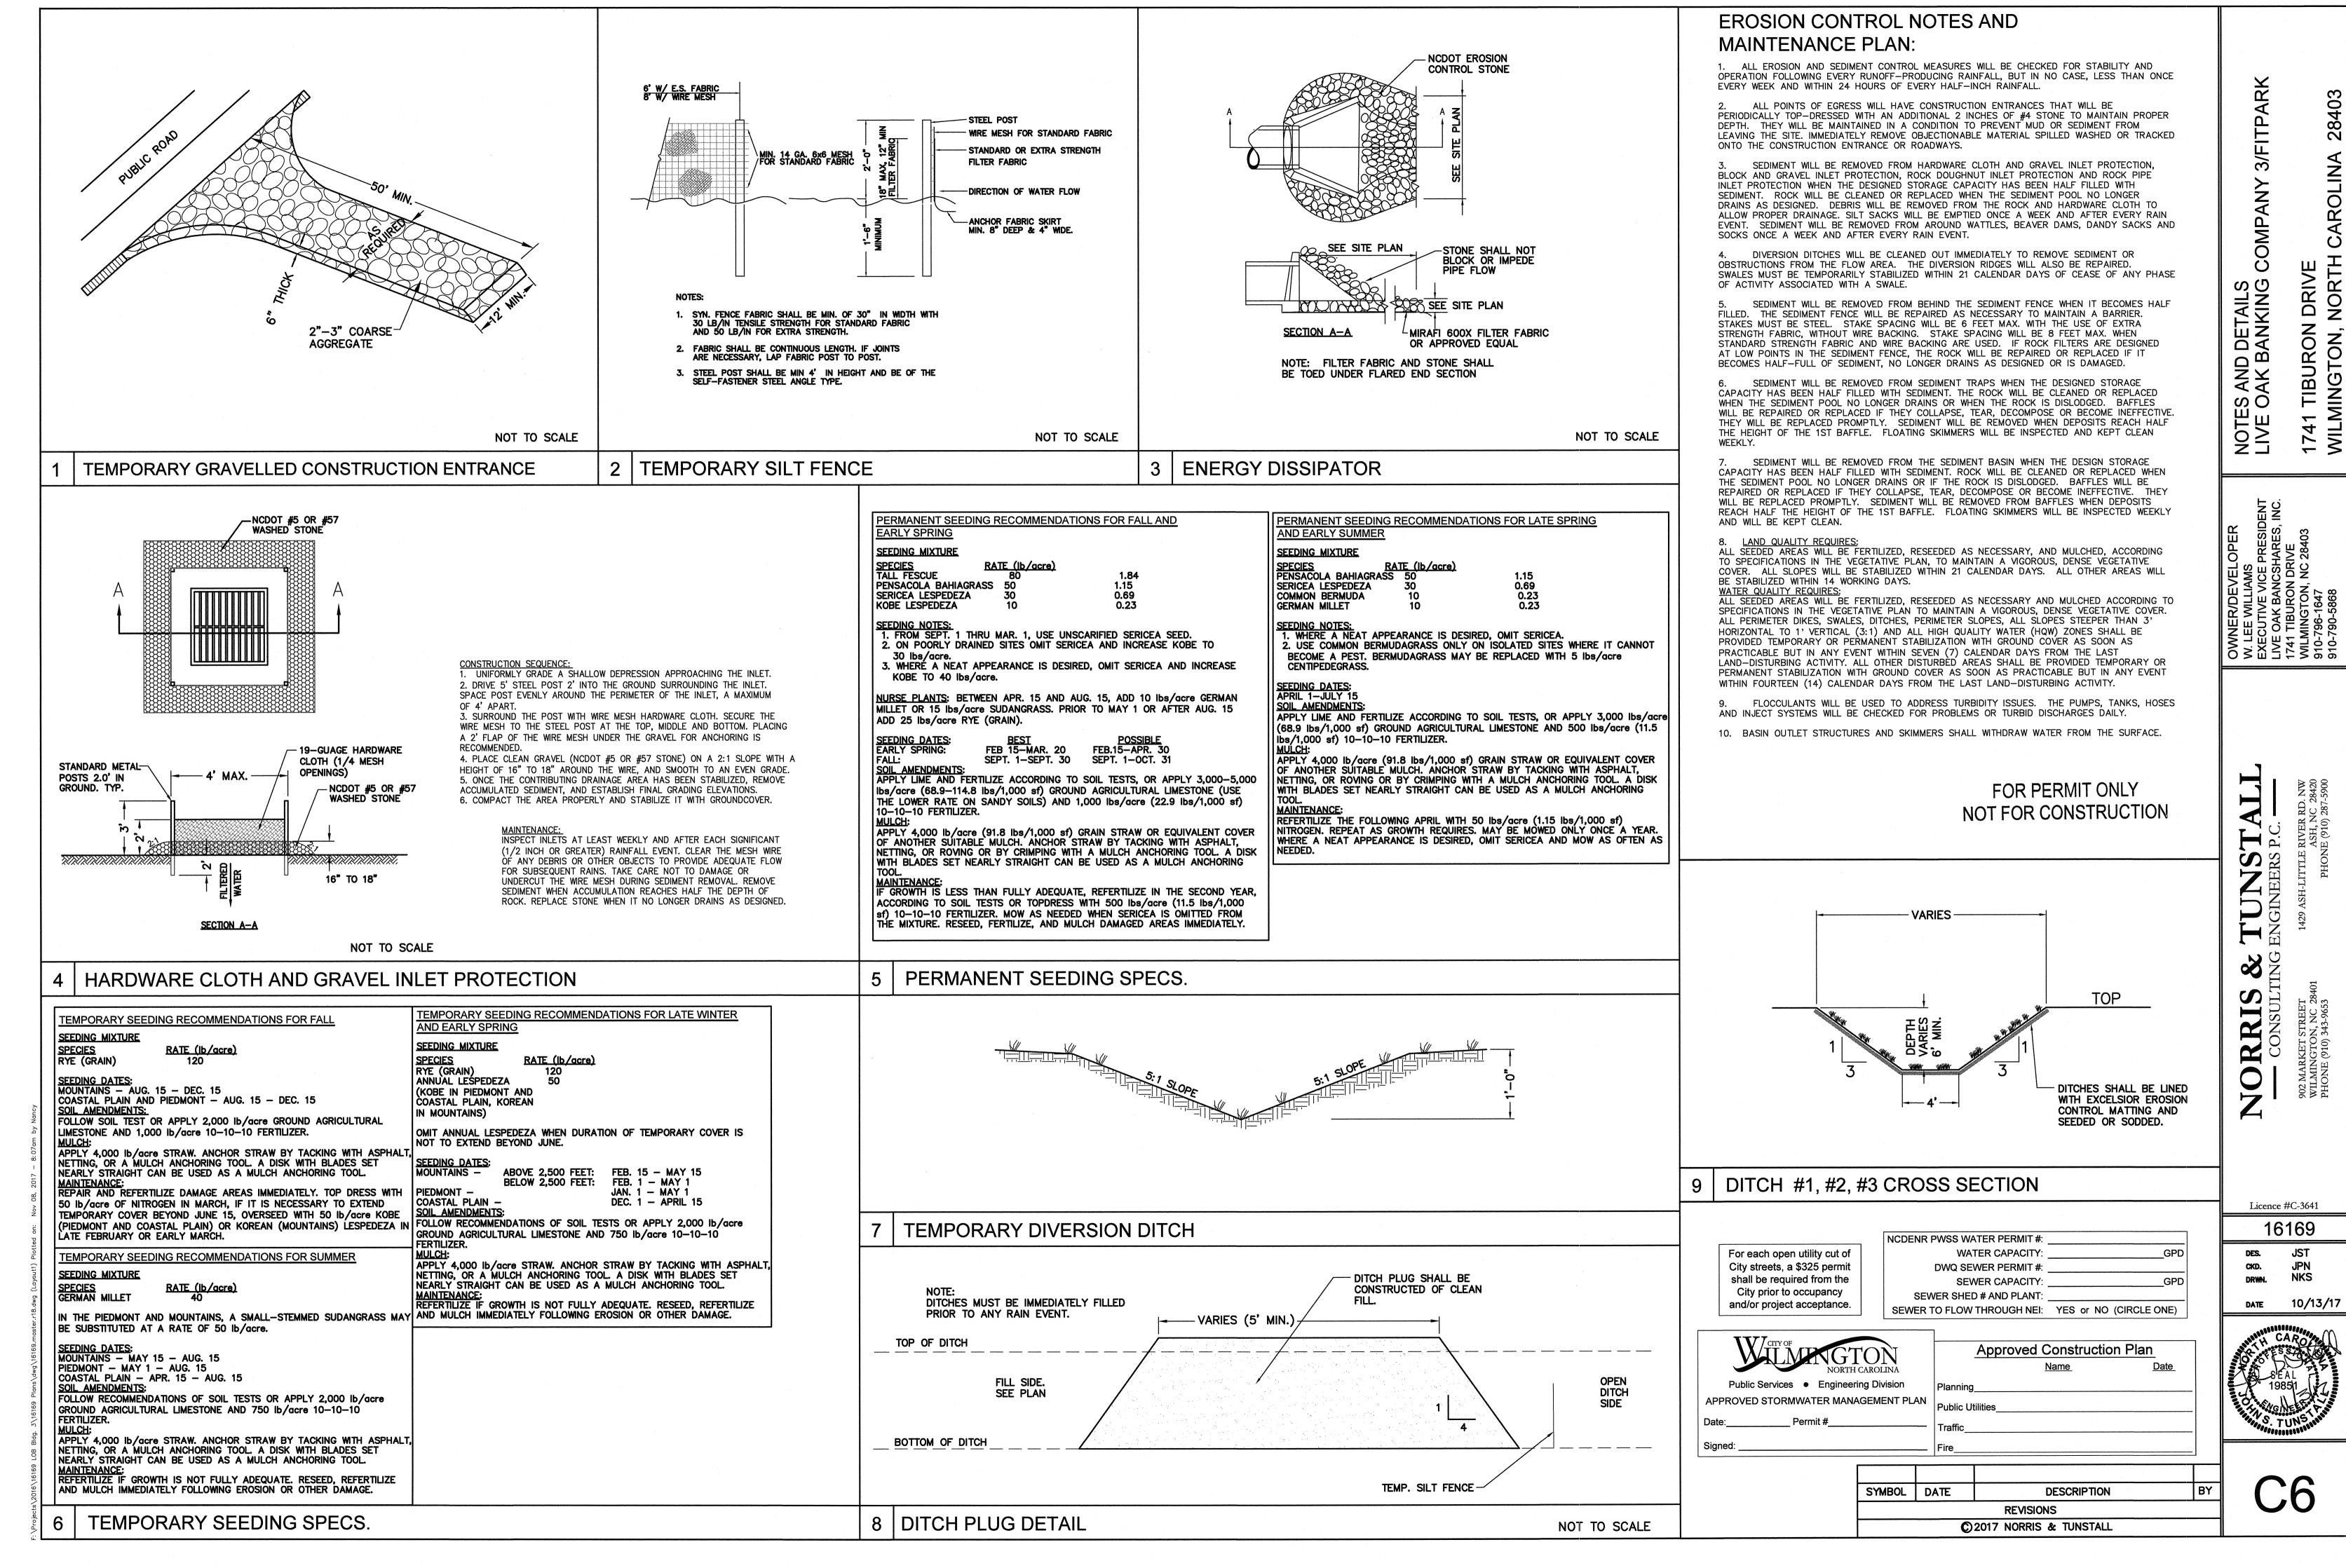

3/FITP/ OMPANY AND DETAILS

AK BANKING RON,

TA P.C. -TUNS

RR

1

Licence #C-3641

16169

JST CKD.

JPN NKS

10/13/17 DATE

City prior to occupancy and/or project acceptance. Approved Construction Plan <u>Date</u>

